TOWN OF BENNETT

Related Projects:

P. E. UNDER PROJECT:

Project Number

Project Code:

R.O.W. Projects:

INDEX OF SHEETS


SHEET NO.

R.O.W. Project Description


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HIGHWAY CONSTRUCTION BID PLANS OF PROPOSED FEDERAL AID PROJECT NO. STU 0704-248 I-70 (EXIT 304) / SH 79 INTERCHANGE IMPROVEMENTS ARAPAHOE COUNTY

CONSTRUCTION PROJECT CODE NO. 23180R

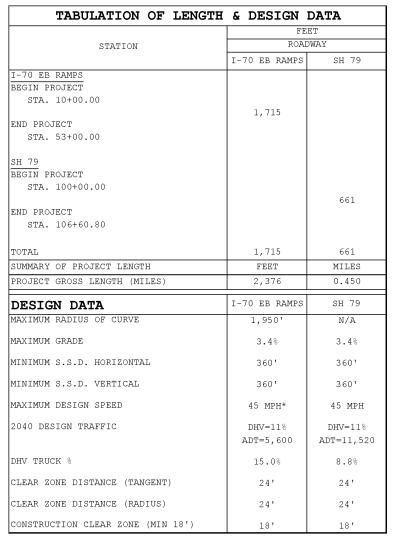


 $[\]star$ 45 MPH AT C2, 30 MPH AT C3, 20 MPH AT L3, 30 MPH AT L4

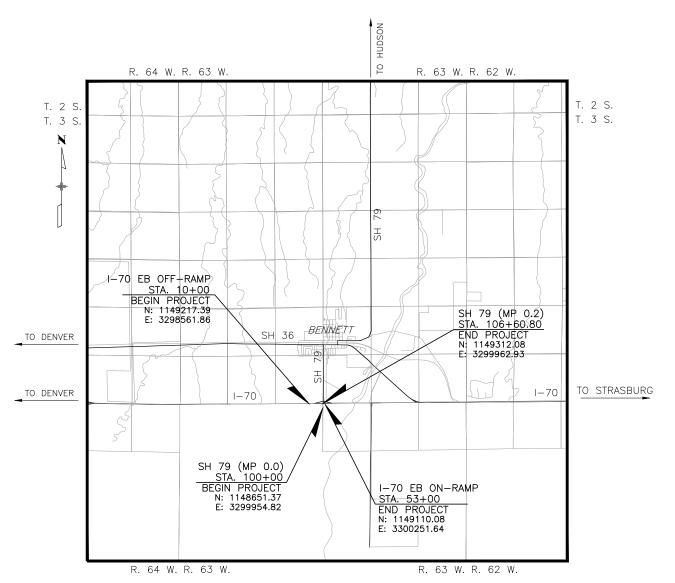

TITLE SHEET 2 STANDARDS PLANS LIST 3 TYPICAL SECTION SURVEY TABULATION SHEET SURVEY CONTROL DIAGRAM 5 6-7 GENERAL NOTES 8-11 SUMMARY OF APPROXIMATE QUANTITIES 12-13 **TABULATIONS** 14 ALIGNMENT CONTROL PLAN 15 REMOVAL PLANS 16-18 ROADWAY PLAN & PROFILE 19 INTERSECTION PLAN 20 PAVING PLAN STORM DRAIN PLAN & PROFILE 21 22-26 TRAFFIC SIGNAL PLANS 27 INTERCONNECT PLAN 28-30 SIGNING AND STRIPING PLANS 31-32 DETOUR PLANS 33-35 CONSTRUCTION PHASING PLANS 36-41 STORMWATER MANAGEMENT PLANS EROSION CONTROL PLANS 42-43 44 UTILITY GENERAL NOTES 45 UTILITY PLAN 46-48 SUBSURFACE UTILITY ENGINEERING (SUE) PLANS XS1-XS4 ROADWAY CROSS SECTIONS

PROJECT LOCATION MAP

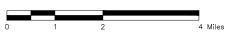

ADVERTISEMENT

Print Date: 2/9/23		Sheet Revisions		
File Name: I70—SH79_TITLE	SHEET.DWG	Date:	Comments	Init.
Horiz. Scale: 0.5:1	Vert. Scale: As Noted			
Unit Information	Unit Leader Initials			
Short Elliott Hendrickson Inc. Colorado Center Tower One Suite 6000	Tele. (720) 540-6800 (800) 490-4966			
2000 South Colorado Boulevard Denver, CO 80222-7900	Fax (720) 540-6801			



As Constructed		Contract Information	Project No./Code
F	, , , , , , , , , , , , , , , , , , , ,	Contractor:	, , , , , , , , , , , , , , , , , , , ,
	No Revisions:	Resident Engineer:	STU 0704-248
	Revised:	Project Engineer:	23180R
F		PROJECT STARTED:/ ACCEPTED:/	
	Void:	Comments:	Sheet Number 1

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COLORADO
DEPARTMENT OF TRANSPORTATION
M&S STANDARDS PLANS LIST
July 31, 2019

Revised on February 9, 2023

ALL OF THE M&S STANDARD PLANS, AS SUPPLEMENTED AND REVISED, APPLY TO THIS PROJECT WHEN USED BY DESIGNATED PAY ITEM OR SUBSIDIARY ITEM.

THE M&S STANDARD PLANS USED TO DESIGN THIS PROJECT ARE INDICATED BY A MARKED BOX , AND WILL BE ATTACHED TO THE PLANS. ALL THE OTHER M&S STANDARD PLANS ARE STILL ELIGIBLE FOR CONSTRUCTION IF APPROVED BY AN APPROPRIATE CDOT ENGINEER.

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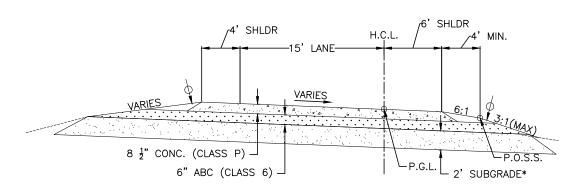
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PLAN

Print Date: 2/9/23		Sheet Revisions			
File Name: I70-SH79_STAN	DARD PLAN LIST.DWG	Date:	Comments	Init.	
Horiz. Scale: 0.5:1	Vert. Scale: As Noted				
Unit Information	Unit Leader Initials				
Short Elliott Hendrickson Inc. Colorado Center Tower One Suite 6000	Tele. (720) 540-6800 (800) 490-4966				
2000 South Colorado Boulevard	Fax (720) 540-6801				




As Constructed	STANDARDS PLANS LIST Project No./(Project No./Code
No Revisions:	STANDARDS	STU 0704-248	
Revised:	Designer: A. MARQUEZ	Structure Numbers	23180R
Void:	Detailer: M. WAGNER Sheet Subset: SPL	Subset Sheets: 1 of 1	Sheet Number 2




<u>I-70 RAMP TYPICAL SECTION</u> OFF-RAMP STA 18+35.68 TO STA 23+99.98 ON-RAMP STA 50+14.18 TO STA 51+68.88


*SUBGRADE IS MOISTURE CONDITIONED AND RECOMPACTED (A-6 OR BETTER WITH MIN. R-VALUE OF 19).

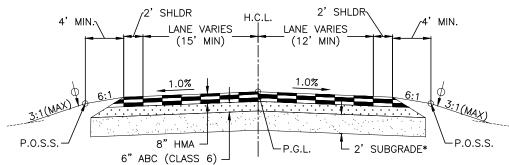

SH 79 TYPICAL SECTION STA 102+74.67 TO STA 103+59.21

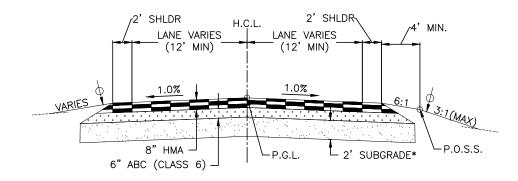


SH 79 TYPICAL SECTION STA 104+25.10 TO STA 105+30.36

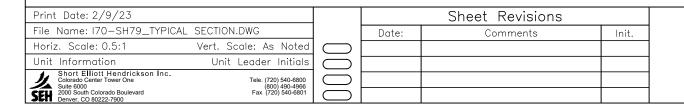




TOWN OF BENNETT 207 MUEGGE WAY BENNETT, CO 80102 TELE. (303) 644-3249 FAX (303) 644-4125

Project No./Code As Constructed TYPICAL SECTION No Revisions: STU 0704-248 A. MARQUEZ Structure Designer: Revised: 23180R K. KULESZA Numbers Detailer: 3 Void: Sheet Number Sheet Subset: TYPSECT Subset Sheets: 1 of 1

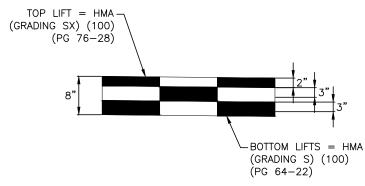


HMA PAVEMENT SECTION

(REQUIRES 3 LIFTS)

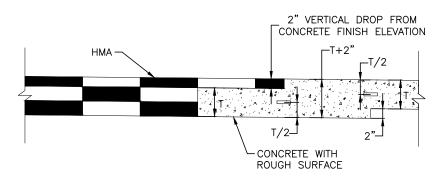

ASPHALT TO CONCRETE TRANSITION

(NOT TO SCALE)

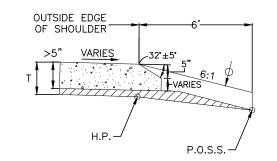

NOTES:

SAFETY EDGE IS NOT INCLUDED IN
 THE WIDTH OF THE TYPICAL SECTION.

CONCRETE AND HOT MIX ASPHALT SAFETY EDGE DETAIL

P.G.L. ~ Profile Grade Line H.M.A. ~ Hot Mix Asphalt

H.P. ~ Hinge Point

P.O.S.S. ~ Point of Slope Selection

~ Minimum 6" Topsoil or Specified Alternative

____ HMA - Hot Mix Asphalt (Section 403)

Concrete (Section 412)

Special Interval

Short Elliott Hendrickson Inc

Suite 6000 2000 South Colorado Boulevar

Tele. (720) 540-6800

么 SH

TO ESTABLISH GEOMETRIC CONTROL FOR THE CONSTRUCTION OF THIS


PROJECT. THE DEPARTMENT HAS PROVIDED THE FOLLOWING INFORMATION:

I pole locations and elevati pole locations and elevatio locations		Proper Horizor Gradin Slope Minor Major One fi	ntal Alignment g Staking Structures	he project) to the Engineer:
1122	TOWN OF DENINETT	As Constructed	SURVEY TABULATION	Project No./Code
Bennett	TOWN OF BENNETT 207 MUEGGE WAY BENNETT, CO 80102	No Revisions:	SURVET TABULATION	STU 0704-248
	TELE. (303) 644-3249	Revised:	Designer: A. MARQUEZ Structure	23180R
	FAX (303) 644-4125	\ \ \ \ \ \ \ \ \ \ \ \ \ \ \ \ \ \ \	Detailer: K. KULESZA Numbers	
welcome neighbors.		Void:	Sheet Subset: SURVTAB Subset Sheets: 1 of 1	Sheet Number 4

Pavement Marking (Section 627)

___ Striping (Temp)

Striping

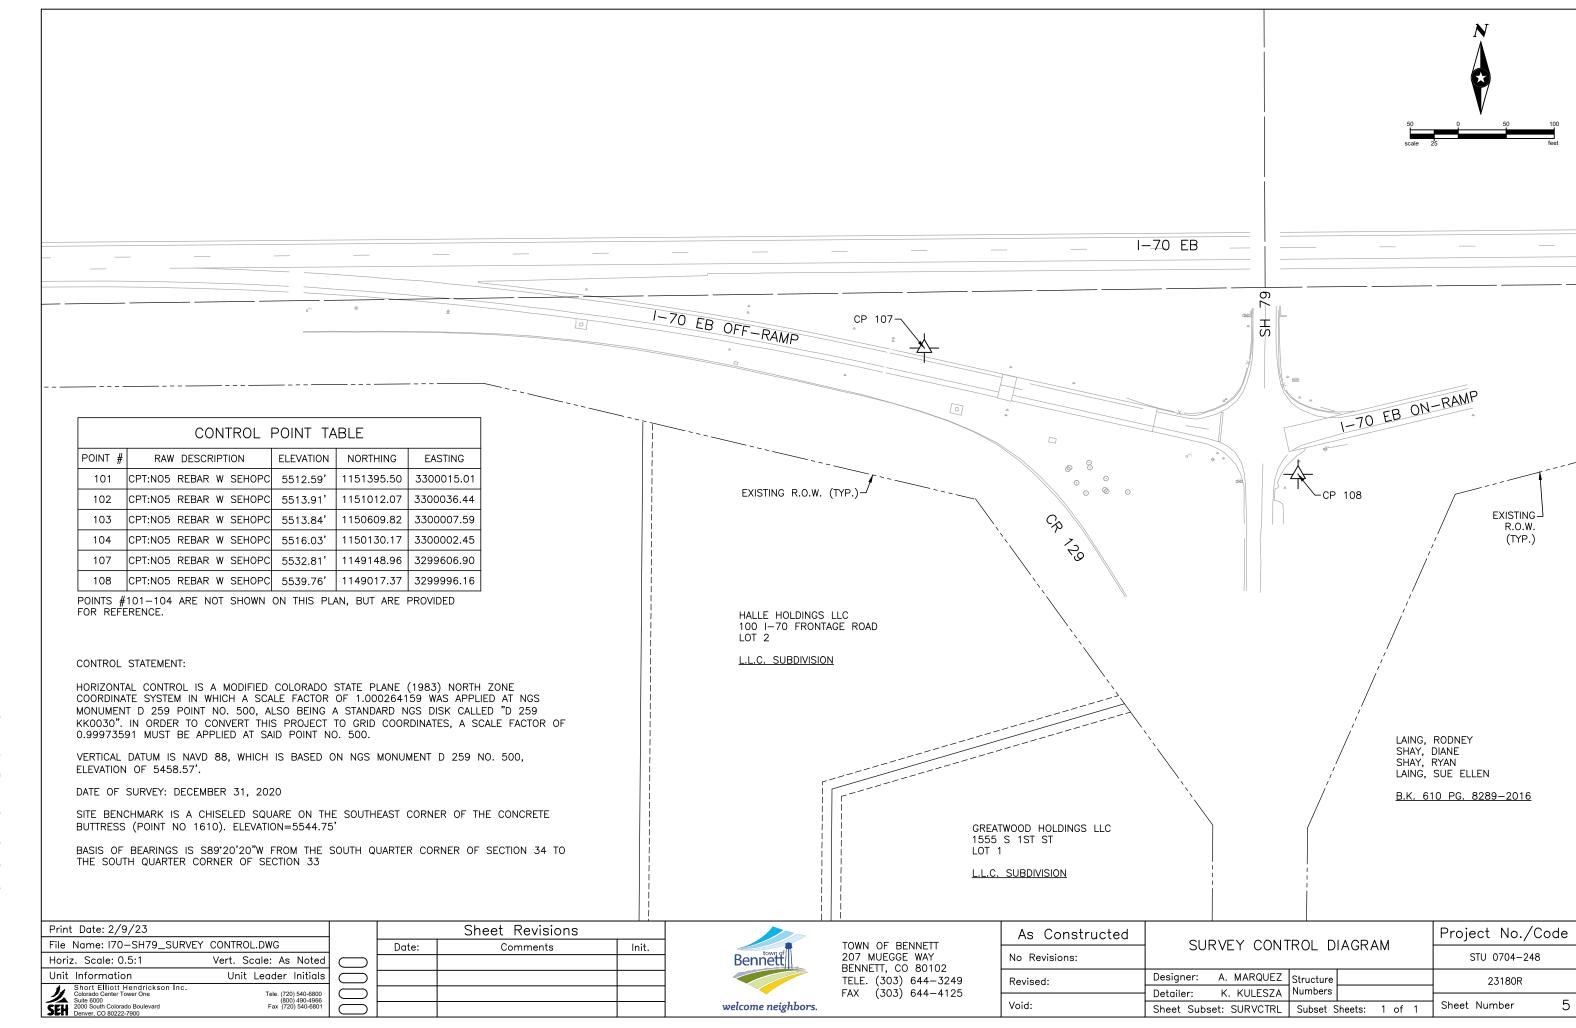

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2. FOR PRELIMINARY PLAN QUANTITIES OF PAVEMENT MATERIALS, THE FOLLOWING RATES OF APPLICATION WERE USED.

TACK COAT DILUTED EMULSIFIED HOT MIX ASPHALT

0.10 GAL. PER SQ. YD. (DILUTED) ASPHALT (SLOW-SETTING)

146.7 LBS. / CU. FT.

AGGREGATE BASE COURSE

133 LBS. / CU. FT. (ABC CLASS 6 SHALL MEET REQUIREMENTS OF 703.03)

- 3. DILUTED EMULSIFIED ASPHALT FOR TACK COAT SHALL CONSIST OF 1 PART EMULSIFIED ASPHALT AND 1 PART WATER. THIS WILL NOT BE PAID FOR SEPARATELY AND IS INCLUDED IN THE COST FOR ITEM 403, HOT MIX ASPHALT.
- 4. THE FOLLOWING SHALL BE FURNISHED WITH EACH ASPHALT PAVER.
 - * A SKI TYPE DEVICE AT LEAST 30 FEET IN LENGTH. (50 FEET IN LENGTH FOR FINAL LIFT)
 - * SHORT SKI SHOE
 - * 1500 FEET OF CONTROL LINE AND STAKES
- 5. ANY LAYER OF ASPHALT PAVEMENT THAT IS TO HAVE A SUCCEEDING LAYER PLACED THEREON SHALL BE COMPLETED FULL WIDTH BEFORE THE SUCCEEDING LAYER IS PLACED.
- 6. A TACK COAT IS REQUIRED BETWEEN ALL LIFTS OF HMA, WHICH WILL BE CONSIDERED SUBSIDIARY TO ITEM 403 AND WILL NOT BE PAID FOR SEPARATELY.
- 7. WHERE PAVEMENT IS TO ABUT EXISTING PAVEMENT, THE EXISTING PAVEMENT SHALL BE REMOVED TO A NEAT VERTICAL LINE, USING A SAW OR OTHER METHOD AS APPROVED, TO CREATE A CLEAN CONSTRUCTION JOINT. THERE SHALL BE NO SEPARATE PAYMENT FOR SAW CUTTING. THE CONTRACTOR WILL ALSO BE REQUIRED TO PAINT THE EDGE WITH DILUTED EMULSIFIED ASPHALT (SLOW—SETTING) PRIOR TO PAVING OPERATIONS. THE RATE OF APPLICATION SHALL BE AS DETERMINED BY THE ENGINEER AT THE TIME OF APPLICATION.
- 8. WATER SHALL BE USED AS A DUST PALLIATIVE AS DIRECTED BY THE ENGINEER. LOCATIONS SHALL BE AS DIRECTED. COST FOR DUST PALLIATIVE SHALL NOT BE MEASURED AND PAID FOR SEPARATELY, BUT SHALL BE CONSIDERED INCIDENTAL TO THE WORK.
- 9. DEPTH OF MOISTURE DENSITY CONTROL FOR THIS PROJECT SHALL BE AS FOLLOWS:

FULL DEPTH OF EMBANKMENT FOR ROADWAY SUBGRADE BELOW ROADBED ~ 2 FEET DEPTH BASES OF CUTS ~ 8 INCHES DEPTH BASES OF FILLS ~ 8 INCHES DEPTH (AFTER TOPSOIL STRIPPING)

- 10. EXCAVATION REQUIRED FOR COMPACTION OF BASES OF CUT AND FILLS WILL BE CONSIDERED SUBSIDIARY TO ITEM 203, AND WILL NOT BE PAID FOR SEPARATELY.
- 11. DETERMINE EMBANKMENT MATERIAL OPTIMUM MOISTURE AND MAXIMUM DENSITY VALUES PER AASHTO T-99 AND AASHTO T-180 ACCORDING TO SECTION 203 OF THE STANDARD SPECIFICATIONS.
- 12. FULL COMPLIANCE PAVEMENT MARKINGS AND ROADSIDE DELINEATION SHALL BE IN PLACE AT THE END OF EACH WORKING DAY UNLESS OTHERWISE APPROVED BY THE ENGINEER.
- 13. IF ANY SOIL CONTAMINATION IS SUSPECTED WHILE EXCAVATING, IMMEDIATELY CONTACT THE ENGINEER AND FOLLOW STANDARD SPECIAL 250.
- 14. THE CONTRACTOR SHALL NOT STOCKPILE ANY MATERIAL WITHIN CDOT R.O.W. UNLESS APPROVED BY THE ENGINEER.
- 15. THE CONTRACTOR SHALL SUBMIT A PLAN ADDRESSING LOCAL DRAINAGE DURING EACH PHASE OF CONSTRUCTION TO THE ENGINEER FOR REVIEW. THIS SHALL NOT BE PAID FOR SEPARATELY, BUT SHALL BE INCLUDED IN THE WORK.
- 16. CONTROL OF SURFACE RUNOFF AND REPAIR OF DAMAGES RESULTING FROM RUNOFF IS SOLELY THE RESPONSIBILITY OF THE CONTRACTOR AND SHALL BE INCLUDED IN THE COST OF THE WORK.
- 17. ALL SHOULDERS AND OTHER PAVED AREAS SHALL BE SWEPT ON A DAILY BASIS TO REMOVE ANY FOREIGN DEBRIS FROM THE SHOULDER AND TRAVELED WAY. ALL SWEEPING OPERATIONS SHALL BE DONE BY A PICK-UP TYPE BROOM AND SHALL NOT BE PAID FOR SEPARATELY, BUT SHALL BE INCLUDED IN THE WORK.
- 18. THE CONTRACTOR SHALL PROTECT ALL EXISTING UTILITIES DURING CONSTRUCTION AND IS RESPONSIBLE FOR ANY DAMAGE THERETO.
- 19. CLEARING AND GRUBBING WILL NOT BE ALLOWED BEYOND THE CONSTRUCTION LIMITS OR REQUIRED CLEAR ZONE. THIS WORK WILL BE MEASURED AND PAID FOR PER ACRE.

Sheet Revisions

Comments

Init.

20. APPROPRIATE MEASURES WILL BE TAKEN TO PREVENT THE INTRODUCTION AND SPREAD OF NOXIOUS WEEDS BY RE-ESTABLISHING A PERMANENT DESIRABLE VEGETATION COMMUNITY WITHIN PROJECT LIMITS, WHICH THE CONSTRUCTION

Date:

Bennett welcome neighbors.

TOWN OF BENNETT
207 MUEGGE WAY
BENNETT, CO 80102
TELE. (303) 644-3249
FAX (303) 644-4125

 As Constructed
 GENERAL NOTES
 Project No./Code

 No Revisions:
 STU 0704-248

 Revised:
 Designer: A. MARQUEZ Detailer: M. WAGNER Numbers
 Structure Numbers
 23180R

 Void:
 Sheet Subset: GENNOTES Subset Sheets: 1 of 2
 Sheet Number

CONTRACTOR MUST FOLLOW.

21. IT IS ESTIMATED THAT 8 HOURS OF WILDLIFE BIOLOGIST WILL BE REQUIRED FOR THIS PROJECT

- 22. HAZARDOUS MATERIALS, INCLUDING FUELS AND LUBRICATING OILS, SHALL NOT BE STORED ANYWHERE ON THE CORRIDOR.

 23. THE CONTRACTOR SHALL LIMIT CONSTRUCTION ACTIVITIES TO THOSE AREAS WITHIN THE LIMITS OF DISTURBANCE
- AND/OR TOES OF SLOPE AS SHOWN ON THE PLANS AND CROSS SECTIONS. ANY DISTURBANCE BEYOND THESE LIMITS SHALL BE RESTORED TO ORIGINAL CONDITIONS BY THE CONTRACTOR AT HIS/HER OWN EXPENSE. CONSTRUCTION ACTIVITIES, IN ADDITION TO NORMAL CONSTRUCTION PROCEDURES, SHALL INCLUDE THE PARKING OF VEHICLES OR EQUIPMENT, DISPOSAL OF LITTER, AND ANY OTHER ACTION WHICH WOULD ALTER EXISTING CONDITIONS.
- 24. IN FILL SECTIONS, THE BASES UPON WHICH EMBANKMENT MATERIAL IS TO BE PLACED BELOW THE ROADBED SHALL BE SCARIFIED TO A DEPTH OF 8 INCHES AND THEN RECOMPACTED WITH MOISTURE AND DENSITY CONTROL. IN CUT SECTIONS, THE EARTH SHALL BE REMOVED FROM THE FULL WIDTH OF THE ROADBED TO THE DESIGNATED DEPTH AND THE EARTH SUBGRADE SHALL BE THOROUGHLY SCARIFIED TO A DEPTH OF 2 FEET AND THEN RECOMPACTED WITH MOISTURE AND DENSITY CONTROL. THE MOISTURE CONTENT OF THE SCARIFIED MATERIAL SHALL BE INCREASED OR DECREASED, AS NECESSARY, TO OBTAIN THE TYPE OF COMPACTION SPECIFIED. SCARIFICATION AND COMPACTION WILL NOT BE PAID FOR SEPARATELY, BUT SHALL BE CONSIDERED SUBSIDIARY TO ROADWAY CONTRACT PAY ITEM 203, UNCLASSIFIED EXCAVATION (CIP)
- 25. ALL EMBANKMENT MATERIAL SHALL CONSIST OF MATERIAL WHICH IS A NON-EXPANSIVE, GRANULAR SOIL. THE CONTRACTOR SHALL FURNISH EVIDENCE THAT THE EMBANKMENT MATERIAL FROM THE SITE OR OTHER SOURCES, FOR USE IN THE ROADWAY EMBANKMENT, MEETS THE REQUIREMENTS AND SHALL PAY FOR SUCH TESTS AS MAY BE REQUIRED TO SHOW COMPLIANCE. NEW EMBANKMENT SHALL BE BENCHED INTO THE EXISTING SLOPES WHERE REQUIRED IN ACCORDANCE WITH 203.06 OF THE STANDARD SPECIFICATIONS. THE MINIMUM THICKNESS OF THE TOPSOIL SHALL BE 6 INCHES AND WILL BE OBTAINED FROM THE CONTRACTOR'S SOURCES. THE TOPSOIL SHALL BE APPLIED TO ALL DISTURBED AREAS, OR AS DIRECTED BY THE FNGINFFR.
- 26. THE CONTRACTOR SHALL MAINTAIN ACCESS TO ALL EXISTING PROPERTY ACCESSES (INCLUDING RESIDENTIAL AND COMMERCIAL) AT ALL TIMES DURING CONSTRUCTION AT NO ADDITIONAL COST TO THE PROJECT.
- 27. THE CONTRACTOR SHALL MASK ALL SIGNS CONFLICTING WITH CONSTRUCTION SIGNING. THE MASKING OF SIGNS WILL NOT BE MEASURED AND PAID FOR SEPARATELY, BUT SHALL BE INCLUDED IN THE COST OF THE WORK.
- 28. THE CONTRACTOR SHALL BE RESPONSIBLE FOR OBTAINING ALL NECESSARY PERMITS FOR ALL APPLICABLE AGENCIES PRIOR TO COMMENCEMENT OF CONSTRUCTION.
- 29. THE CONTRACTOR SHALL BE RESPONSIBLE FOR ALL ASPECTS OF SAFETY INCLUDING, BUT NOT LIMITED TO, EXCAVATION, TRENCHING, SHORING, TRAFFIC CONTROL, AND SECURITY. REFER TO OSHA PUBLICATION 2226, EXCAVATING AND TRENCHING.
- 30. THE CONTRACTOR SHALL HAVE, ON SITE AT ALL TIMES, ONE (1) COPY OF THE APPROVED PLANS, ONE (1) COPY OF THE APPROPRIATE STANDARDS AND SPECIFICATIONS, AND A COPY OF ANY PERMITS AND EXTENSION AGREEMENTS NEEDED FOR THE JOB.
- 31. IF, DURING THE CONSTRUCTION PROCESS, CONDITIONS ARE ENCOUNTERED WHICH COULD INDICATE A SITUATION THAT IS NOT IDENTIFIED IN THE PLANS OR SPECIFICATIONS, THE CONTRACTOR SHALL CONTACT THE ENGINEER IMMEDIATELY.
- 32. A STATE CONSTRUCTION DEWATERING WASTEWATER DISCHARGE PERMIT IS REQUIRED FOR WATER THAT IS DISCHARGED INTO A STREAM, STORM SEWER, CHANNEL, IRRIGATION DITCH, OR ANY WATERS OF THE UNITED STATES.
- 33. THE CONTRACTOR SHALL COMPLY WITH ALL TERMS AND CONDITIONS OF THE COLORADO PERMIT FOR STORMWATER DISCHARGE (CONTACT COLORADO DEPARTMENT OF HEALTH, WATER QUALITY CONTROL DIVISION, (303) 692—3590), THE STORMWATER MANAGEMENT PLAN, AND THE EROSION CONTROL PLAN.
- 34. TEMPORARY EROSION CONTROL DURING CONSTRUCTION SHALL BE PROVIDED AS SHOWN ON THE EROSION CONTROL PLAN, AND AS DIRECTED BY THE ENGINEER. ALL EROSION CONTROL MEASURES SHALL BE MAINTAINED IN GOOD REPAIR BY THE CONTRACTOR, UNTIL SUCH TIME AS THE ENTIRE DISTURBED AREAS IS STABILIZED WITH HARD SURFACE OR LANDSCAPING.
- 35. THE CONTRACTOR SHALL SUBMIT A CONSTRUCTION TRAFFIC CONTROL PLAN, IN ACCORDANCE WITH MUTCD AND CDOT STANDARD FOR TRAFFIC CONTROL S-630-1, TO TOWN FOR APPROVAL, PRIOR TO ANY CONSTRUCTION ACTIVITIES WITHIN, OR AFFECTING, THE RIGHT-OF-WAY. THE CONTRACTOR SHALL BE RESPONSIBLE FOR PROVIDING ANY AND ALL TRAFFIC CONTROL DEVICES AS MAY BE REQUIRED BY THE CONSTRUCTION ACTIVITIES.
- 36. THERE SHALL BE NO SITE CONSTRUCTION ACTIVITIES ON SATURDAYS, UNLESS SPECIFICALLY APPROVED BY THE ENGINEER, AND NO SITE CONSTRUCTION ACTIVITIES ON SUNDAYS OR HOLIDAYS, UNLESS THERE IS PRIOR WRITTEN APPROVAL BY CDOT AND THE TOWN. A MINIMUM 48 HOURS NOTICE IS REQUIRED.
- 37. WHERE FENCES ARE IMPACTED BY THE CONSTRUCTION, THE CONTRACTOR SHALL BE RESPONSIBLE FOR REMOVING, RESETTING, OR MAINTAINING THE IMPACTED FENCE. ALL PRIVATE LIVESTOCK AREAS SHALL BE MAINTAINED BY THE CONTRACTOR THROUGHOUT CONSTRUCTION OF NEW FENCES OR TEMPORARY FENCES, IF NECESSARY. TEMPORARY FENCE WILL NOT BE MEASURED AND PAID FOR SEPARATELY.
- 38. THE UTILITY INFORMATION SHOWN ON THE PLANS IS PLOTTED FROM THE BEST AVAILABLE INFORMATION. THE CONTRACTOR IS FULLY RESPONSIBLE FOR LOCATING ALL EXISTING UTILITIES AND AVOIDING THEM. REFER TO PARAGRAPH 105.11 OF THE STANDARD SPECIFICATIONS. CONDUIT RUNNING LINE ALIGNMENT MAY BE MOVED TO AVOID EXISTING UTILITIES WITH THE APPROVAL OF THE ENGINEER. CONTRACTOR SHALL NOTIFY THE ENGINEER IMMEDIATELY OF ANY UTILITY CONFLICT WHICH CANNOT BE READILY RESOLVED AND WHICH MAY REQUIRE RE—DESIGN OF ANY PART OF THE PROJECT.

Print Date: 2/9/23

Horiz. Scale: 1:1

Unit Information

File Name: I70-SH79_GENERAL NOTES.DWG

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- 39. IT IS ESTIMATED THAT 100 HOURS OF POTHOLING WILL BE REQUIRED FOR THE PROJECT, AND WILL BE PAID UNDER ITEM 203, POTHOLING. THE CONTRACTOR SHALL SUBMIT A POTHOLING PLAN TO THE ENGINEER AT THE PRE-CONSTRUCTION CONFERENCE FOR APPROVAL WHICH DESCRIBES A PLAN FOR POTHOLING ALL EXISTING FACILITIES THAT MAY BE IMPACTED BY CONSTRUCTION.
- 40. IT IS ANTICIPATED THAT ONE MOBILIZATION WILL BE REQUIRED FOR THIS PROJECT. ONE (1) LUMP SUM (ITEM 626) WILL BE PAID FOR BY THE PROJECT.
- 41. IT IS THE CONTRACTOR'S RESPONSIBILITY TO VERIFY THE EXISTING CONDITIONS.
- 42. THE CONTRACTOR MUST REVIEW WORK SITES WITH THE ENGINEER TO ENSURE WETLANDS THAT ARE IDENTIFIED SHALL BE PROTECTED WITH TEMPORARY FENCE. TEMPORARY FENCE WILL NOT BE PAID FOR SEPARATELY, BUT SHALL BE INCLUDED IN THE COST OF THE WORK.
- 43. SEVERITY OF POTENTIAL SULFATE EXPOSURE ON THIS PROJECT IS CLASS 3. THE CONTRACTOR, AT HIS OWN EXPENSE, SHALL HAVE A CERTIFIED LABORATORY TEST OF THE SUBGRADE AS PER THE CDOT FIELD MATERIAL MANUAL. TESTING SHALL BE AT THE SAME SCHEDULE AND FREQUENCY AS REQUIRED FOR A PRELIMINARY SOIL SURVEY. THE CONTRACTOR MAY PROPOSE A DIFFERENT CLASS OF EXPOSURE FOR THE PROJECT BASED ON THOSE TEST RESULTS.
- 44. THE CONTRACTOR SHALL COMPLY WITH ARTICLE 1.5 OF TITLE 9, CRS ("EXCAVATION REQUIREMENTS") WHEN EXCAVATING OR GRADING IS PLANNED IN THE AREA OF UNDERGROUND UTILITY FACILITIES. THE CONTRACTOR SHALL NOTIFY ALL AFFECTED UTILITIES AT LEAST TWO (2) BUSINESS DAYS, NOT INCLUDING THE ACTUAL DAY OF NOTICE, PRIOR TO COMMENCING SUCH OPERATIONS. THE CONTRACTOR SHALL CONTACT THE UTILITY NOTIFICATION CENTER OF COLORADO (UNCC) AT 811, TO HAVE LOCATIONS OF UNCC REGISTERED LINES MARKED BY MEMBER COMPANIES. ALL OTHER UNDERGROUND FACILITIES SHALL BE LOCATED BY CONTACTING THE RESPECTIVE OWNER. UTILITY SERVICE LATERALS SHALL ALSO BE LOCATED PRIOR TO BEGINNING EXCAVATION OR GRADING. THE CONTRACTOR SHALL LOCATE NON-MEMBER UTILITIES, SUCH AS STORM SEWER AND DITCH FACILITIES AS NECESSARY TO PREVENT DAMAGE THERETO. THE CONTRACTOR SHALL SUBMIT AN IREA ENERGY BUILDERS CALL LINE APPLICATION FOR EVERY IREA ENERGY WORK ELEMENT THAT IS TO BE COORDINATED WITH THE PROJECT.
- 45. THE CONTRACTOR SHALL PROVIDE ONE FIELD OFFICE (CLASS 2), ONE FIELD LABORATORY (CLASS 2), AND ONE SANITARY FACILITY.
- 46. ALL REMOVED ITEMS BECOME THE PROPERTY OF THE CONTRACTOR TO BE DISPOSED OF OFF-SITE WITH THE EXCEPTION OF ALL SIGNS, DELINEATORS, SIGNALS, AND ITS EQUIPMENT, WHICH ARE THE PROPERTY OF THE TOWN OF BENNETT AND SHALL BE DELIVERED TO THE TOWN UNDAMAGED. THE CONTRACTOR SHALL CONTACT THE TOWN FOR FURTHER COORDINATION.
- 47. THE CONTRACTOR SHALL PROTECT ALL MONUMENTS OUTSIDE OF THE CONSTRUCTION LIMITS FROM DAMAGE.
- 48. THIS PROJECT IS NOT SUBJECT TO ROADWAY SMOOTHNESS INCENTIVE/DISINCENTIVE.
- 49. THE CONTRACTOR SHALL PROVIDE A 10' STRAIGHTEDGE FOR SMOOTHNESS VERIFICATION. TESTING SHALL BE PERFORMED AT THE DIRECTION OF THE ENGINEER. AREAS SHOWING HIGH SPOTS OF MORE THAN 3/16 INCH IN 10 SHALL BE CORRECTED USING A METHOD APPROVED BY THE ENGINEER.
- 50. THE CONTRACTOR SHALL SUBMIT A PAVING SCHEDULE TO THE ENGINEER AT LEAST 5 WORKING DAYS PRIOR TO THE PRE-PAVING CONFERENCE. PAVING SHALL NOT BEGIN UNTIL THE SCHEDULE HAS BEEN ACCEPTED IN WRITING BY THE
- 51. THE CONTRACTOR SHALL NOT STOCKPILE MATERIAL OR EQUIPMENT WITHIN 30 FEET OF THE EDGE OF TRAVEL WAY.
- 52. ADDITIONAL MOBILIZATIONS REQUIRED FOR TEMPORARY STRIPING OPERATIONS WILL NOT BE PAID FOR AND ALL TEMPORARY STRIPING WILL BE PAID AT THE UNIT COST REGARDLESS OF ADDITIONAL MOBILIZATIONS.
- 53. CONTRACTOR NOT AUTHORIZED TO PERFORM ANY WORK OUTSIDE RIGHT-OF-WAY.
- 54. THE CONTRACTOR SHALL BE RESPONSIBLE FOR ALL CONSTRUCTION SURVEYING, BOTH LAYOUT AND STAKING OF ALL IMPROVEMENTS FOR APPROVAL BY THE TOWN PRIOR TO INSTALLATION, AND AS-BUILTS OF FINAL INSTALLATIONS. DISCREPANCIES TO THE BASE INFORMATION SHALL BE BROUGHT TO THE TOWN'S ATTENTION FOR A DECISION PRIOR TO COMMENCING WITH THE WORK, NOTIFICATION OF REQUEST FOR FIELD REVIEW SHALL BE MADE A MINIMUM OF 24 HOURS IN ADVANCE. CONSTRUCTION SURVEYING WILL BE PAID FOR UNDER ITEM 625, CONSTRUCTION SURVEYING, ONE (1) LUMP SUM.
- 55. THIS PROJECT IS NOT SUBJECT TO INCENTIVE/DISINCENTIVE PAYMENTS FOR ASPHALT OR CONCRETE PAVEMENT.
- 55. AGGREGATE BASE COURSE CLASS 6 SHALL BE UNDERLAIN BY TWO FEET OF MINIMUM R-19 MATERIAL.
- 56. RECLAIMED ASPHALT PAVEMENT (RAP), ASPHALT MILLINGS, OR ASPHALT IN ANY FORM WHATSOEVER SHALL NOT BE SUBSTITUTED FOR OR USED IN AGGREGATE BASE COURSE (CLASS 6).
- 57. EARLY OPENING CLASS P CONCRETE SHALL ATTAIN A MINIMUM COMPRESSIVE STRENGTH OF 3,000 PSI BEFORE BEING OPENED TO TRAFFIC.
- 58. DOWEL BARS AND TIE BARS SHALL BE REQUIRED FOR ALL PCCP IN ACCORDANCE WITH M STANDARD M-412-1. DOWEL BARS AND TIE BARS SHALL NOT BE PAID FOR SEPARATELY BUT SHALL BE INCLUDED IN THE WORK.
- 59. SEAL JOINTS WITH AN APPROVED SEALING MATERIAL.
- 60. DURING SUSPENSION OF WORK, NO TRAFFIC CONTROL INSPECTION DAYS WILL BE PAID.

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- 61. IT IS ESTIMATED THAT 150 DAYS OF PUBLIC INFORMATION MANAGEMENT (TIER IV) WILL BE REQUIRED FOR THIS PROJECT.
- 62. THE CONTRACTOR SHALL COMPLY WITH ALL LOCAL AGENCY(S) NOISE ORDINANCES AND/OR OTHER RESTRICTIONS APPLICABLE TO NIGHTTIME CONSTRUCTION ACTIVITIES FOR PROJECTS WITHIN THE LOCAL MUNICIPAL COVERAGE AREAS. PROJECTS FALLING WITHIN UNINCORPORATED AREAS OF A COUNTY WILL BE GOVERNED BY COUNTY CODE. THE CONTRACTOR SHALL COORDINATE WITH THE LOCAL AGENCY(S) AND/OR CDOT FOR ALL NECESSARY NOISE EXEMPTIONS OR NOTICES, NOISE PERMIT VARIANCES, AND APPROVALS TO DO NIGHT WORK AS REQUIRED. IF LOCAL AGENCY NIGHTTIME NOISE RESTRICTIONS DO NOT EXIST AND THERE ARE NOISE SENSITIVE RECEPTORS IN THE PROJECT AREA, THE APPROVALS TO DO NIGHTTIME WORK SHALL BE APPROVED THROUGH THE CDOT ENGINEER. STANDARD NOISE CONTROLS AND BEST MANAGEMENT PRACTICES FOR REDUCING EQUIPMENT AND CONSTRUCTION ACTIVITY NOISE LEVELS SHALL BE UTILIZED IN ALL CASES AND WILL BE THE RESPONSIBILITY OF THE CONTRACTOR TO CONSISTENTLY EMPLOY WHEN WORKING IN NOISE SENSITIVE AREAS AFTER 7:00 P.M. FOR THIS PROJECT, THE CONTRACTOR IS REQUIRED TO REVIEW AND UNDERSTAND ALL LOCAL AGENCY ORDINANCES WITH PROJECT APPLICABLE NIGHT RESTRICTIONS. WHEN CONDITIONS APPLY, THE CONTRACTOR SHALL SUBMIT A NIGHTTIME NOISE ORDINANCE MEMORANDUM(S) TO ALL JURISDICTIONAL LOCAL AUTHORITIES. THIS MEMORANDUM SHALL REQUEST CONSTRUCTION NOISE EXEMPTIONS FOR NIGHT WORK OPERATIONS (AT LEAST TWO WEEKS PRIOR TO THE PROPOSED NIGHT WORK START DATE) WHERE CONSTRUCTION WORK IS SCHEDULED BETWEEN THE HOURS OF 7:00 P.M. AND 7:00 A.M. THE FOLLOWING INFORMATION SHOULD BE INCLUDED IN THE EXEMPTION REQUEST SUBMITTALS AND SENT TO THE CITY/COUNTY ENGINEER: (1) REQUESTING ENTITY, (2) CONTACT PERSON AND PHONE NUMBER, (3) LOCATION OF THE WORK, (4) REASONS NIGHT WORK IS BEING REQUESTED, (5) TYPE OF ACTIVITIES PROPOSED TO OCCUR AT NIGHT, (6) EQUIPMENT PROPOSED TO BE USED AT NIGHT, (7) START AND END DATE PROPOSED, (8) TOTAL NUMBER OF NIGHTS WORK IS PROPOSED TO OCCUR. ALL NIGHTTIME CONSTRUCTION ACTIVITIES SUBJECT TO NOISE LEVEL RESTRICTIONS CANNOT BEGIN UNTIL THE NECESSARY DOCUMENTATION AND NOTIFICATIONS HAVE BEEN APPROVED BY THE LOCAL AGENCY AUTHORITY, THE CDOT ENGINEER AND/OR THE REGION'S NOISE SPECIALIST. ALL EXEMPTION REQUESTS AND PERMITTING REQUIREMENTS WILL NOT BE PAID FOR SEPARATELY, BUT WILL BE INCLUDED IN THE WORK.

63. PCCP ACCEPTANCE SHALL UTILIZE COMPRESSIVE STRENGTH CRITERIA

ENVIRONMENTAL NOTES:

TREE TRIMMING/REMOVAL

TREE TRIMMING AND/OR REMOVAL ACTIVITIES SHALL BE COMPLETED BEFORE BIRDS BEGIN TO NEST OR AFTER THE YOUNG HAVE FLEDGED. IN COLORADO, MOST NESTING AND REARING ACTIVITIES OCCUR BETWEEN APRIL 1 AND AUGUST HOWEVER, SINCE SOME BIRDS NEST AS EARLY AS FEBRUARY, A NESTING BIRD SURVEY SHALL BE CONDUCTED BY A BIOLOGIST BEFORE ANY TREE TRIMMING OR REMOVAL ACTIVITIES BEGIN.

2. CLEARING/GRUBBING ACTIVITIES

CLEARING AND GRUBBING OF VEGETATION THAT MAY DISTURB GROUND NESTING BIRDS SHALL BE COMPLETED BEFORE BIRDS BEGIN TO NEST OR AFTER THE YOUNG HAVE FLEDGED. IF WORK ACTIVITIES ARE PLANNED BETWEEN APRIL 1 AND AUGUST 31. VEGETATION SHALL BE REMOVED AND/OR TRIMMED TO A HEIGHT OF SIX (6) INCHES OR LESS PRIOR TO APRIL 1. ONCE VEGETATION HAS BEEN REMOVED AND/OR TRIMMED, APPROPRIATE MEASURES, I.E. REPEATED MOWING/TRIMMING, SHALL BE IMPLEMENTED TO ASSURE VEGETATION DOES NOT GROW MORE THAN SIX (6) INCHES. FAILURE TO MAINTAIN VEGETATION HEIGHT OF SIX (6) INCHES OR LESS MAY POSTPONE PROJECT CONSTRUCTION.

TOWN OF BENNETT 207 MUEGGE WAY

BENNETT, CO 80102

TELE. (303) 644-3249

FAX (303) 644-4125

A NEST SURVEY MUST BE CONDUCTED SEVEN (7) DAYS PRIOR TO CONSTRUCTION. IF ANY RAPTORS/NESTS ARE OBSERVED THEN COLORADO PARKS AND WILDLIFE MUST BE CONTACTED AND THEIR GUIDELINES FOLLOWED.

- 4. IN THE EVENT THAT SUSPECTED ASBESTOS CONTAINING MATERIAL (ACM) IS ENCOUNTERED, INCLUDING WITH BURIED UTILITIES, THE CONTRACTOR WILL FOLLOW CDOT SPECIFICATION 250.07 - ASBESTOS-CONTAINING MATERIAL MANAGEMENT, AS WELL AS CDOT REGULATED ASBESTOS-CONTAMINATED SOIL MANAGEMENT STANDARD OPERATING PROCEDURE, ADDITIONALLY, DEPENDING ON THE TYPE OF ACM, THIS MATERIAL MUST ALSO BE ABATED IN ACCORDANCE WITH EITHER SECTION 5.5 OF THE SOLID WASTE REGULATIONS, OR REGULATION NO. 8 OF THE AIR QUALITY CONTROL COMMISSION REGULATIONS.
- ALTHOUGH ENCOUNTERING IMPACTED SOIL OR GROUNDWATER IS NOT EXPECTED. WORKERS SHALL BE ALERT DURING EXCAVATION FOR ANY VISUAL OR OLFACTORY SIGNS OF CONTAMINATION. IF IMPACTED SOIL AND/OR GROUNDWATER IS ENCOUNTERED, WORK WILL STOP IMMEDIATELY AND THE PROCEDURES OUTLINED IN THE COLORÁDO DEPARTMENT OF TRANSPORTATION (CDOT) SPECIFICATION 250 - ENVIRONMENTAL HEALTH AND SAFETY MANAGEMENT SHALL BE FOLLOWED.
- 6. THE CONTRACTOR SHALL CONTROL FUGITIVE DUST THROUGH IMPLEMENTATION OF SECTIONS 107.24, 209, AND 250 OF CDOT'S STANDARD SPECIFICATIONS FOR ROAD AND BRIDGE CONSTRUCTION, AND THE AIR POLLUTION CONTROL DIVISION'S AIR POLLUTANT EMISSION NOTIFICATION (APEN) REQUIREMENTS.

THE FOLLOWING BEST MANAGEMENT PRACTICES SHALL BE IMPLEMENTED DURING CONSTRUCTION:

- · MAINTAIN ENGINES AND EXHAUST SYSTEMS ON CONSTRUCTION EQUIPMENT AND VEHICLES IN GOOD WORKING ORDER. PROHIBIT TAMPERING WITH EQUIPMENT TO INCREASE HORSEPOWER OR DISABLING EMISSION CONTROL DEVICES. EQUIPMENT IS SUBJECT TO INSPECTION BY THE PROJECT MANAGER TO ENSURE MAINTENANCE IS CONDUCTED REGULARLY.
- PROHIBIT UNNECESSARY IDLING OF CONSTRUCTION EQUIPMENT AND VEHICLES.
- · LOCATE STAGING AREAS AND STATIONARY CONSTRUCTION EQUIPMENT/DIESEL ENGINES AS FAR AS POSSIBLE FROM RESIDENCES AND OTHER SENSITIVE RECEPTORS.
- COVER, WET, COMPACT, OR CHEMICAL STABILIZATION TO CONTROL DUST FROM DISTURBED AREAS AND EXCAVATED MATERIALS DURING CONSTRUCTION. MINIMIZE DISTURBED AREAS, PARTICULARLY DURING DRY WEATHER CONDITIONS, AND USE WIND BARRIERS AS APPROPRIATE.
- EMPLOY WHEEL WASH STATIONS AT POINTS OF INGRESS/EGRESS. USE STREET SWEEPERS TO REMOVE SOIL TRACKED ONTO ADJACENT ROADWAYS.
- 8. IF PALEONTOLOGICAL OR ARCHAEOLOGICAL/CULTURAL RESOURCES ARE UNCOVERED DURING PROJECT CONSTUCTION, WORK IN THE IMMEDIATE AREA OF THE FIND SHALL CEASE, AND EITHER THE CDOT HQ PALEONTOLOGIST (NICOLE PEAVEY: 303.757.9632, NICOLE.PEAVEY@STATE.CO.US) OR THE CDOT HQ ARCHAEOLOGIST (GREG WOLFF: 303.757.9158 GREG.WOLFF@STATE.CO.US) SHALL BE NOTIFIED AS SOON AS POSSIBLE PER SECTION 107.23 OF THE STANDARD SPECIFICATIONS

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воок	PAGE	SHEET	ITEM NO.	CONTRACTITEM	UNIT	PLAN	AS CONST.	PLAN	AS CONST.
			201-00000	Clearing and Grubbing	L S	1.00		1.00	
			202-00010	Removal of Tree	EACH	2		2	
			202-00090	Removal of Delineator	EACH	10		10	
			202-00210	Removal of Concrete Pavement	SY	1,644		1,644	
			202-00220	Removal of Asphalt Mat	sy	1,634		1,634	
			202-00700	Removal of Light Standard	EACH	2		2	
			202-00810	Removal of Ground Sign	EACH	5		5	
			202-00821	Removal of Sign Panel	EACH	1		1	
			202-01130	Removal of Guardrail Type 3	LF	330		330	
			202-04002	Clean Culvert	EACH	5		5	
			203-00010	Unclassified Excavation (Complete In Place)	СҮ	1,003		1,003	
			203-00050	Unsuitable Material	СУ	100		100	
			203-01100	Proof Rolling	HOUR	20		20	
			203-01597	Potholing	HOUR	100		100	
			207-00700	Topsoil (Onsite)	СУ	485		485	
			207-00704	Subgrade Soil Preparation	SY	2,909		2,909	
			208-00002	Erosion Log Type 1 (12 Inch)	LF	300		300	
			208-00020	Silt Fence	LF	1,800		1,800	
			208-00046	Pre-fabricated Concrete Washout Structure (Type 1)	EACH	1		1	
			208-00075	Pre-fabricated Vehicle Tracking Pad	EACH	2		2	
			208-00103	Removal and Disposal of Sediment (Labor)	HOUR	8		8	
			208-00105	Removal and Disposal of Sediment (Equipment)	HOUR	8		8	
			208-00106	Sweeping (Sediment Removal)	HOUR	100		100	
			210-00810	Reset Ground Sign	EACH	13		13	
			210-01011	Reset Gate	EACH	1		1	
			210-04020	Modify Inlet	EACH	1		1	
			212-00706	Seeding (Native) Drill	ACRE	2		2	
			213-00002	Mulching (Weed Free Hay)	ACRE	1		1	
			213-00061	Mulch Tackifier	LB	162		162	
			216-00201	Soil Retention Blanket (Straw-Coconut) (Biodegradable Class 1)	sy	3,365		3,365	

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2000 South Colorado Boulevard	Fax (720) 540-6801		



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As Constructed	SUMMARY OF APPROXIMATE Project No./Co		
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Revised:	Designer: A. MARQUEZ		23180R
	Detailer: M. WAGNER	Numbers	_
Void:	Sheet Subset: SOAQ	Subset Sheets: 1 of 4	Sheet Number 8

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воок	PAGE	SHEET	ITEM NO.	CONTRACTITEM	UNIT	PLAN	AS CONST.	PLAN	AS CONST.
			217-00020	Herbicide Treatment	HOUR	8		8	
			240-00000	Wildlife Biologist	HOUR	8		8	
			304-06000	Aggregate Base Course (Class 6)	TON	1,324		1,324	
			403-00721	Hot Mix Asphalt (Patching) (Asphalt)	SY	200		200	
			403-33841	Hot Mix Asphalt (Grading S) (100) (PG 64-22)	TON	496		496	
			403-34871	Hot Mix Asphalt (Grading SX) (100) (PG 76-28)	TON	165		165	
			412-00850	Concrete Pavement (8-1/2 Inch)	SY	1,798		1,798	
			412-00870	Concrete Pavement (8-1/2 Inch) (Fast Track)	SY	315		315	
			412-02000	Concrete Safety Edge	LF	1,350		1,350	
			503-00036	Drilled Shaft (36 Inch)	LF	57		57	
			603-01240	24 Inch Reinforced Concrete Pipe	LF	30		30	
			604-00305	Inlet Type C (5 Foot)	EACH	1		1	
			606-00302	Guardrail Type 3 (31 Inch Midwest Guardrail System)	LF	188		188	
			606-02003	End Anchorage (Nonflared)	EACH	2		2	
			612-00001	Delineator (Type I)	EACH	5		5	
			612-00003	Delineator (Type III)	EACH	1		1	
			612-00041	Delineator (Flexible) (Type I)	EACH	4		4	
			613-00206	2 Inch Electrical Conduit (Bored)	LF	355		355	
			613-00306	3 Inch Electrical Conduit (Bored)	LF	370		370	
			613-01200	2 Inch Electrical Conduit (Plastic)	LF	55		55	
			613-01300	3 Inch Electrical Conduit (Plastic)	LF	70		70	
			613-07199	Pull Box (Install Only)	EACH	4		4	
			613-10000	Wiring	LS	1		1	
			613-13000	Luminaire (LED) (Special)	EACH	3		3	
			613-80130	Service Meter Cabinet	EACH	1		1	
			614-00011	Sign Panel (Class I)	SF	18		18	
			614-00012 Sign Panel (Class II)		SF	37		37	
				Sign Panel (Class II) (Install Only)	EACH	1		1	
			614-01573	Steel Sign Support (2-1/2 Inch Round NP-40)(Post & Slipbase)	EACH	2		2	
			1310nm SFP Optic Module	EACH	2		2		

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воок	PAGE	SHEET	ITEM NO.	CONTRACT ITEM	UNIT	PLAN	AS CONST.	PLAN	AS CONST.
			614-70337	Traffic Signal Face (12-12-12) (Install Only)	EACH	11		11	
			614-72836	Conflict Monitor	EACH	1		1	
			614-72855	Traffic Signal Controller Cabinet	EACH	1		1	
			614-72866	Fire Preemption Unit and Timer	EACH	3		3	
			614-72887	Microwave Vehicle Radar Detector	EACH	4		4	
			614-81301	Traffic Signal-Light Pole (1 Mast Arm) (Install Only)	EACH	3		3	
			614-86248	Traffic Signal Controller (Type 2070LC)	EACH	1		1	
			614-86800	Uninterrupted Power Supply	EACH	1		1	
			614-87010	Fiber Optic Cable (Single Mode) (12 Fiber)	LF	1490		1,490	
			614-87012	Fiber Optic Termination Panel (12 Fiber)	EACH	1		1	
			614-87015	Buffer Tube Fan Out Kit	EACH	1		1	
			614-87320	Closed Circuit Television	EACH	1		1	
			614-87350	Test Fiber Optic Cable	L S	1		1	
			614-87512	Splice Fiber Optic Cable (12 Strand)	EACH	1		1	
			614-87692	Ethernet Switch Type II	EACH	1		1	
			620-00002	Field Office (Class 2)	EACH	1		1	
			620-00012	Field Laboratory (Class 2)	EACH	1		1	
			620-00020	Sanitary Facility	EACH	1		1	
			621-00450	Detour Pavement	sy	713		713	
			625-00000	Construction Surveying	LS	1		1	
			626-00000	Mobilization	LS	1		1	
			626-01114	Public Information Management (Tier IV)	DAY	150		150	
			627-00001	Pavement Marking Paint (Temporary)	GAL	13		13	
			627-00008	Modified Epoxy Pavement Marking	GAL	13		13	
			627-30405	Preformed Thermoplastic Pavement Marking (Word- Symbol)	SF	73		73	
			627-30410	Preformed Thermoplastic Pavement Marking (Xwalk-Stop Line)	SF	157		157	
		630-00000 Flagging		HOUR	640		640		
			630-00003	Uniformed Traffic Control	HOUR	640		640	
			630-00006	Uniformed Traffic Control (Vehicle)	HOUR	640		640	
			630-00007	Traffic Control Inspection	DAY	35		35	

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	Detailer: M. WAGNER	Numbers			
Void:	Sheet Subset: SOAQ	Subset Sheets: 3 of 4	Sheet Number 10		

	INDEX		CONTRACT	CONTRACT ITEM	UNIT	Roadway				PROJECT TOTALS	
воок	PAGE	SHEET	ITEM NO.	CONTRACTITEM	UNIT	PLAN	AS CONST.			PLAN	AS CONST
			630-00012	Traffic Control Management	DAY	80				80	
			630-80336	Barricade (Type 3 M-B) (Temporary)	EACH	8				8	
			630-80341	Construction Traffic Sign (Panel Size A)	EACH	65				65	
			630-80342	Construction Traffic Sign (Panel Size B)	EACH	22				22	
			630-80344	Construction Traffic Sign (Special)	SF	48				48	
			630-80355	Portable Message Sign Panel	EACH	7				7	
			630-80358	Advance Warning Flashing or Sequencing Arrow Panel (C Type)	EACH	2				2	
			630-80360	Drum Channelizing Device	EACH	100				100	
			630-80370	Barrier (Temporary)	LF	464				464	
			630-80380	Traffic Cone	EACH	50				50	
			630-80393	Stackable Vertical Panels	EACH	50				50	
			630-85010	Impact Attenuator (Temporary)	EACH	2				2	
			630-85041	Mobile Attenuator	DAY	80				80	
			700-70010	F/A Minor Contract Revisions	FA	1				1	
			700-70019	F/A Asphalt Cement Cost Adjustment	FA	1				1	
			700-70380	F/A Erosion Control	FA	1				1	
			700-70589	F/A Environmental Health & Safety Management	FA	1				1	

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Horiz. Scale: 1:1	Vert. Scale: As Noted		
Unit Information	Unit Leader Initials		
Short Elliott Hendrickson Inc. Colorado Center Tower One Suite 6000	Tele. (720) 540-6800 (800) 490-4966		
2000 South Colorado Boulevard Denver, CO 80222-7900	Fax (720) 540-6801		



Init.

As Constructed	SUMMARY OF APPROXIMATE	Project No./Code			
No Revisions:	QUANTITIES	STU 0704-248			
Revised:	Designer: A. MARQUEZ Structure	23180R			
	Detailer: M. WAGNER Numbers				
Void:	Sheet Subset: SOAQ Subset Sheets: 4 of 4	Sheet Number 11			

SPECIFICATION.

	THWORK QUANTITIES O QUANTITY		
FOR PAY JNCLASSIFIED EXCAVATION (COMPLETE IN PLACE)	Y QUANTITY	CUBIC YARDS	
SH 79		99	BCY
I-70 Off-Ramp		790	BCY
I-70 On-Ramp		114	BCY
	TOTAL FOR PAY QUANTITY	1,003	ВСҮ
JNSUITABLE MATERIAL		CUBIC YARDS	
Project		100	BCY
	TOTAL FOR PAY QUANTITY	100	ВСҮ
FOR INFOR	MATION ONLY		
EARTHWORK QU	ANTITIES BALANCE		
EMBANKMENT MATERIAL (COMPLETE IN PLACE)		CUBIC YARDS	
SH 79		2	CCY
I-70 Off-Ramp		784	CCY
I-70 On-Ramp		94	CCY
Detour Temporary Widening		217	CCY
	TOTAL	1,097	CCY
<u>NASTE</u>			
EXCAVATED MATERIAL TO BE DISPOSED OF BY	CONTRACTOR TOTAL	-94	всу
	TOTAL	-0-4	БОТ
COMPACTION (AASHTO T 99)		CUBIC YARDS	
BASES OF CUTS AND FILLS (8")	TOTAL	1,410	CCY CCY
		CUBIC YARDS	
WATER FOR COMPACTION (0.04 MGAL/CUBIC YARD)			

CCY - COMPACTED CUBIC YARD - ONE CUBIC YARD OF MATERIAL AFTER IT HAS BEEN COMPACTED TO

			SURFA	ACING SUMI	MARY			
		304-06000	403-34871	403-3	33841	412-00850 Concrete Pavement (8-	412-00870	
STATION TO STATION	SIDE	Aggregate Base	Hot Mix Asphalt (Grading SX) (100) (PG 76-28)		(Grading S) (100) 64-22)		Concrete Pavement (8-	COMMENT
		Course (Class 6)	2 INCH TOP LIFT	3 INCH MIDDLE 3 INCH BOTTOM		1/2 Inch)	1/2 Inch) (Fast Track)	
		TON	TON	TON	TON	SY	SY	
I-70 Off-Ramp	1							
18+35.68 to 23+83.70	Rt. & Lt.	489				1,375	200	
SH 79								
102+74.67 to 105+30.67	Rt. & Lt.	434	157	236	236			
I-70 On- Ramp								
50+61.06 to 51+68.88	Rt. & Lt.	135				337	100	
	SUB-TOTALS	1,058	157	236	236	1,712	300	
5% IRREGULARITIES A	DJUSTMENT	53	8	12	12	86	15	
PROJ	ECT TOTALS	1,111	165	4:	96	1,798	315	

	TABULATION OF REMOVALS, RESETS AND ADJUSTMENTS												
		201-00000	202-00010	202-00090	202-00210	202-00220	202-00700	202-00810	202-00821	202-01130	210-00810	210-01011	210-04020
STATION TO STATION	SIDE	Clearing and Grubbing	Removal of Tree	Removal of Delineator	Removal of Concrete Pavement	Removal of Asphalt Mat	Removal of Light Standard	Removal of Ground Sign		Removal of Guardrail Type 3	Reset Ground Sign	Reset Gate	Modify Inlet
		LS	EACH	EACH	SY	SY	EACH	EACH	EACH	LF	EACH	EACH	EACH
I-70 Off Ramp													
18+35.68 to 23+01.58	Rt. & Lt.				1247								
18+35.68 to 24+06.81	Rt & Lt.	0.8											
18+43.11	Rt.							1					
19+37.64	Lt.			1									
19+95.17	Lt.			1									
20+12.00	Rt. & Lt.										2		
20+94.75	Rt.												1
21+08.12	Lt.			1									
21+29.97 to 21+46.51	Rt. & Lt.					42							
21+45.32	Rt.								1		1		
21+48.00	Rt. & Lt.										2		
22+04.43	Lt.										1		
22+37 to 22+45	Rt.		2										
22+66.34	Lt.			1									
22+94.19	Lt.			1									
23+64.07	Rt.						1						
23+71.42	Rt.							2					
23+72.00	Rt. & Lt.										2		
23+75.17	Lt.							2					
SH 79													
102+74.67 to 105+30.36	Rt. & Lt.					1592							
103+77	Lt.			1									
104+33	Lt.			1									
104+34.09 to 105+14.45	Lt.									139			
104+44.21 to 105+14.77	Rt.									191			
104+81	Lt.			1									
105+20.39	Lt.										1		
I-70 On Ramp	1												
50+00.00 to 51+68.88	Rt. & Lt.	0.2											
50+26.45 to 51+68.88	Rt. & Lt.				397								
50+39.73	Lt.			1									
50+43.07	Lt.										1		
50+50.30	Lt.										1		
50+60.73	Lt.			1									
50+64.14	Rt.						1						
50+72.00	Rt. & Lt.										2		
50+75.74 to 50+77.02	Rt. & Lt.											1	
PROJECT	T TOTALS	1	2	10	1,644	1,634	2	5	1	330	13	1	1

	TABULATION OF SIGNS										
	PAY ITEM						614-00012	614-01573			
SIGN NUMBER	SIGN CODE	LEGEND	BACKGROUND COLOR	STATION	LT/RT	/RT TRAVEL DIRECTION	T/DT ····	DIMENSION	SIGN PANEL (CLASS II)	STEEL SIGN SUPPORT (2-1/2 INCH ROUND NP- 40) (POST & SLIPBASE)	COMMENTS
								SF	EACH		
1	W13-2	"EXIT 45 MPH"	YELLOW	3+87.5	RT	EB	36"x48"	12.00	1		
2	W13-3	"RAMP 45 MPH"	YELLOW	15+49.43	RT	WB	48"x48"	16.00			
3	W3-3	SIGNAL	YELLOW	18+43.11	RT	EB	36"x36"	9.00	1		
			1		ļ.	PR	OJECT TOTALS	37.00	2		

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Unit Information	Unit Leader Initials						
Short Elliott Hendrickson Inc. Colorado Center Tower One Suite 6000	Tele. (720) 540-6800 (800) 490-4966						
SEH 2000 South Colorado Boulevard Denver, CO 80222-7900	Fax (720) 540-6801						



As Constructed	TABULATIONS Project No./		
No Revisions:	TABUL	STU 0704-248	
Revised:	Designer: A. MARQUEZ		23180R
	Detailer: M. WAGNER	Numbers	
Void:	Sheet Subset: TABS	Subset Sheets: 1 of 2	Sheet Number 12

TABULATION OF DRAINAGE STRUCTURES							
		603-01240	604-00305				
STATION TO STATION	SIDE	24 Inch Reinforced Concrete Pipe	Inlet Type C (Foot)				
		LF	EACH				
70 Off-Ramp							
20+94.75 to 22+11.71	Rt.	30					
22+11.71	Rt.		1				
PRO	OJECT TOTAL	30	1				

	SUMMARY O	F STRIPING		
PAY	ITEM 627-00008	627-30405	627-30210	
COLOR	MODIFIED EPOXY PAVEMENT MARKING	PREFORMED THERMOPLASTIC PAVEMENT MARKING (WORD-SYMBOL)	THERMOPLASTIC PAVEMENT MARKING (X WALK-STOP LINE)	
	GAL	SF	SF	
WHITE	11	73	157	
YELLOW	2			
PROJECT TOTA	ALS 13	73	157	

NOTES:

- 1. APPLICATION RATE FOR EPOXY PAVEMENT MARKING IS ESTIMATED AT 85 SQ FT PER GALLON.
- 2. APPLICATION RATE FOR PAVEMENT MARKING PAINT (WATERBORNE) IS ESTIMATED AT 90 SQ FT PER GALLON.
- 3. SEE STRIPING PLANS FOR DETAILS.

	TEMPORARY TRAFFIC CONTROL SIGN TABULATION									
SIGN CODE	LEGEND	DIMENSIONS -			ZE					
SIGN CODE	LEGEND	DIMENSIONS	A B C 3 3 3 2 3 4 3 4 1 3 2 2 2 4 1	С						
R52-6a	"BEGIN FINES DOUBLE IN WORK ZONE"	36"x48"		3						
W20-1	"ROAD WORK AHEAD"	36"x36"	3							
G20-11	"ROAD WORK MM YY MM YY FOR INFORMATION XXX-XXX-XXX"	48"x48"		3						
W20-4	"ONE LANE ROAD XX FT"	36"x36"	2							
W20-7	FLAGGER	36"x36"	3							
R52-6b	"END FINES DOUBLE IN WORK ZONE"	36"x48"		4						
G20-5	"WORK ZONE"	36"x24"	3							
W13-2	" EXIT XX M.P.H.	36"x48"		3						
G20-10	"XYZ CONSTRUCTION THANKS YOU"	48"x48"		4						
W13-3	"RAMP XX M.P.H."	36x48"		1						
W20-2	"DETOUR AHEAD"	36"x36"	3							
W4-2(R)	"LANE ENDS"	36"x36"	2							
W20-5(R)	"LANE CLOSED"	36"x36"	2							
W20-63	"RAMP WORK AHEAD"	36"x36"	4							
M4-10	"DETOUR"	48"x18"	2							
R11-2	"ROAD CLOSED"	48"x30"	1							
E5-2a	"EXIT CLOSED"	"48"x36"		2						
M1-1	"INTERSTATE 70"	36"x36"	7							
M4-8	"DETOUR"	24"x12"	7							
M6-1	Left Arrow Symbol	21"x15"	2							
M6-1	Right Arrow Symbol	21"x15"	2							
M3-3	"EAST"	24"x12"	7							
M4-9r	"DETOUR"	48"x36"		1						

		612-0	00001	612-00003	612-0004	
STATION ⁽¹⁾	SIDE		Delineator (Type I)		Delineator (Flexible) (Type 1)	
		Crystal	Yellow	Yellow	Yellow	
		EACH	EACH	EACH	EACH	
I-70 Off Ramp						
19+37.96	LT		1			
20+36.63	LT		1			
21+36.40	LT		1			
22+37.98	LT		1			
23+60.41	LT			1		
SH 79						
103+74.14	LT	1				
104+24.63	LT				1	
104+48.17	LT				1	
I-70 On Ramp						
50+50.99	LT				1	
50+74.87	LT				1	
PROJECT TOTALS			5	1	4	

	627-30405	627-30410				
STATION TO STATION	SIDE		D EPOXY T MARKING	PREFORMED THERMOPLASTIC PAVEMENT MARKING (WORD-SYMBOL)	PREFORMED THERMOPLASTIC PAVEMENT MARKING (XWALK-STOPLINE STOP BAR WHITE WIDE	
STATION TO STATION	SIBE	CENTER LINE DOUBLE YELLOW, 4 INCH	EDGE LINE, SOLID WHITE 6 INCH	RAMP PAVEMENT ARROW		
		SF	SF	SF	SF	
I-70 Off-Ramp						
20+03.00	Lt.			24.3		
21+40.00	Lt.			24.3		
23+60.00	Lt.			24.3		
18+35.68 to 24+08.81	Rt. & Lt.		650			
23+82.09	Rt. & Lt.				96	
SH 79						
102+74.67 to 103+59.21	Rt. & Lt.	56				
103+59.21	Rt.				37	
104+54.11	Lt.				24	
104+54.11 to 105+30.36	Rt. & Lt.	51				
I-70 On-Ramp						
50+00.00 to 51+68.88	Rt. & Lt.		241			
PROJECT	TOTAL (SF)	107	890	73	157	

ITEM NO.	ITEM	UNIT	PROJEC TOTALS
630-00000	FLAGGING	HOUR	640
630-00003	UNIFORMED TRAFFIC CONTROL	HOUR	640
630-00006	UNIFORMED TRAFFIC CONTROL (VEHICLE)	HOUR	640
630-00007	TRAFFIC CONTROL INSPECTION	DAY	35
630-00012	TRAFFIC CONTROL MANAGEMENT	DAY	80
630-80336	BARRICADE (TYPE 3 M-B) (TEMPORARY)	EACH	8
630-80341	CONSTRUCTION TRAFFIC SIGN (PANEL SIZE A)	EACH	65
630-80342	CONSTRUCTION TRAFFIC SIGN (PANEL SIZE B)	EACH	22
630-80344	CONSTRUCTION SIGN (SPECIAL)	SF	48
630-80355	PORTABLE MESSAGE SIGN PANEL	EACH	7
630-80358	ADVANCE WARNING FLASHING or SEQUENCING AROW PANEL (C TYPE)	EACH	2
630-80360	DRUM CHANNELIZING DEVICE	EACH	100
630-80380	TRAFFIC CONE	EACH	50
630-80393	STACKABLE VERTICAL PANELS	EACH	50
630-85041	MOBILE ATTENUATOR	DAY	80


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File Name: I70-SH79_TABULATIONS.DWG			Date:	Comments
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Unit Information	Unit Leader Initials			
Short Elliott Hendrickson Inc Colorado Center Tower One Suite 6000	Tele. (720) 540-6800 (800) 490-4966			
SEH 2000 South Colorado Boulevard Denver, CO 80222-7900	Fax (720) 540-6801			




Init.

As Constructed	TABUL	Project No./Code		
No Revisions:	TABUL	STU 0704-248		
Revised:	Designer: A. MARQUEZ		23180R	
Void:	Detailer: M. WAGNER Sheet Subset: TABS	Numbers Subset Sheets: 2 of 2	Sheet Number 13	

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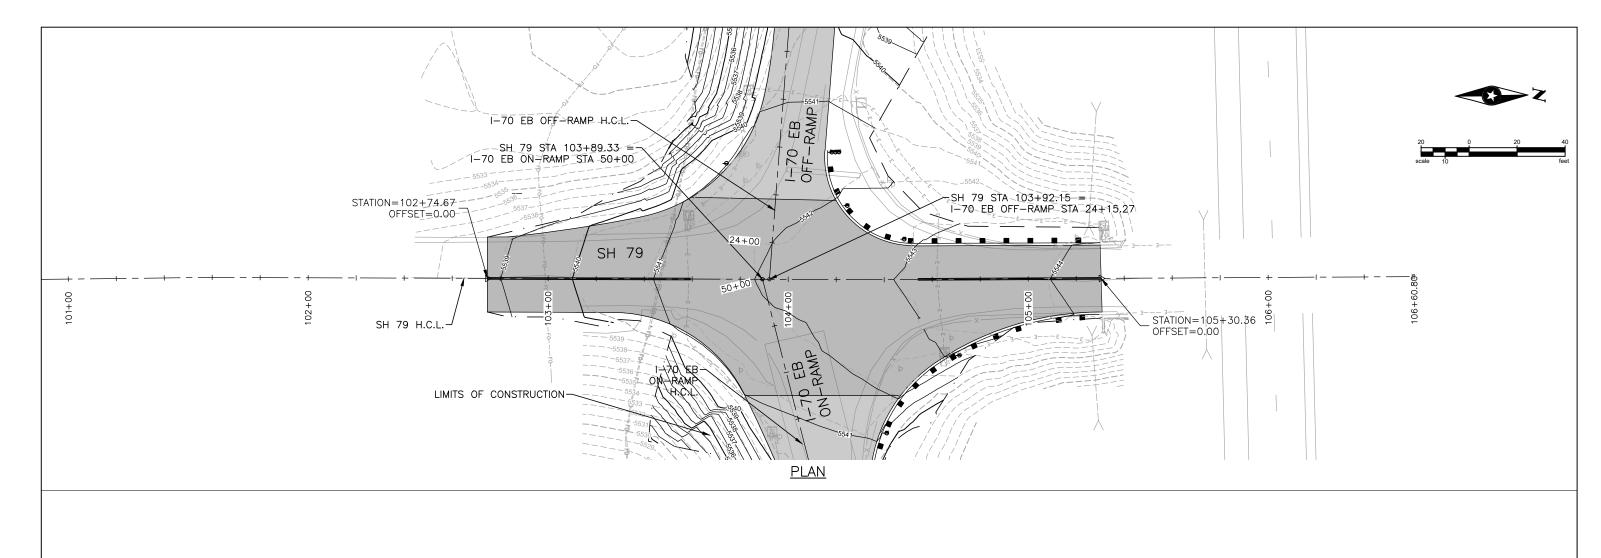
OUTSIDE EDGE OF TRAVEL PROFILE

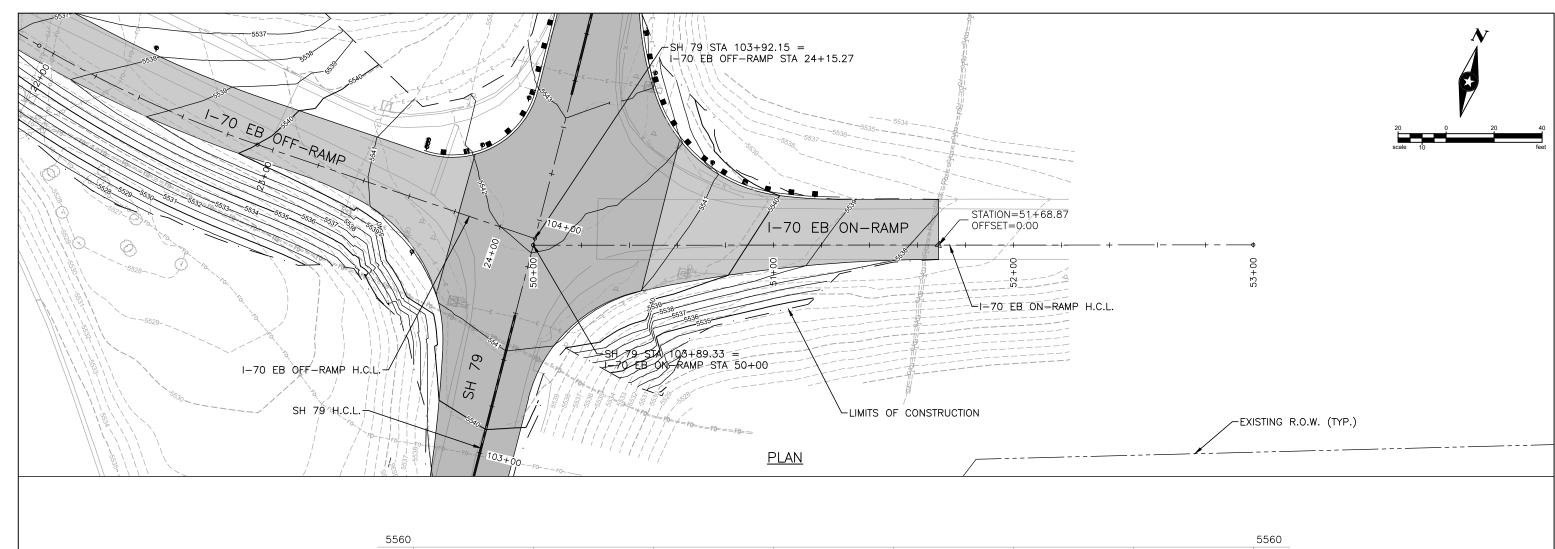
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Unit Information Unit Leader Initials			Г
Short Elliott Hendrickson Inc. Tele. (720) 540-6800 Suite 6000 (800) 490-4966			Γ
2000 South Colorado Boulevard Fax (720) 540-6801 Denver, CO 80222-7900			

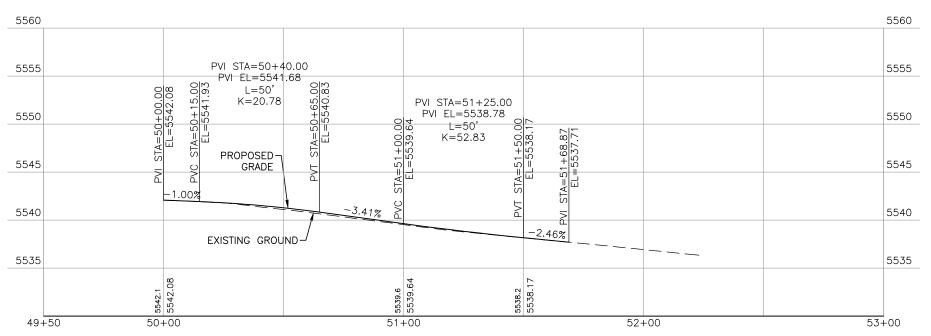

Init.

As Constructed	ROADWAY PLAI	Project No./Code	
No Revisions:	I-70 EB	STU 0704-248	
Revised:	Designer: A. MARQUEZ		23180R
	Detailer: K. KULESZA	Numbers	
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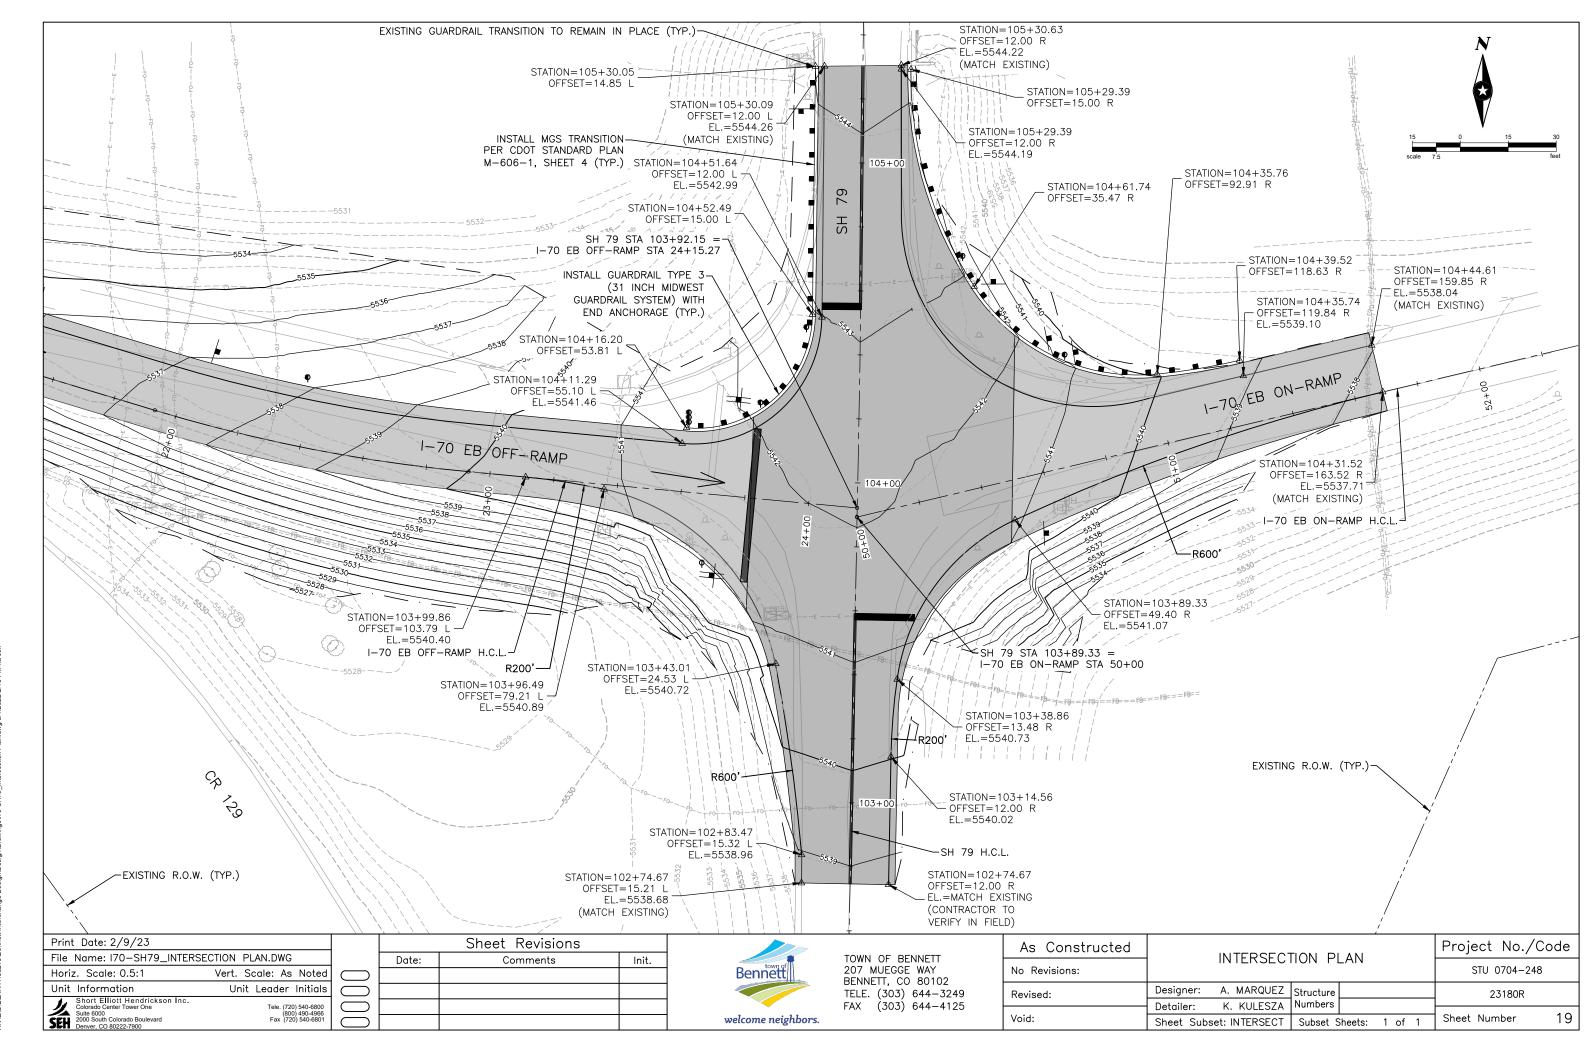


CENTERLINE PROFILE
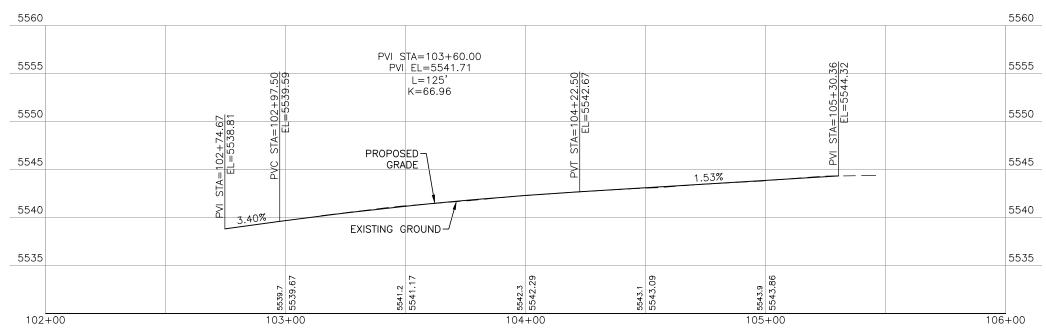
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As Constructed	ROADWAY PLAN AN	Project No./Code	
No Revisions:	SH 79	STU 0704-248	
Revised:	Designer: A. MARQUEZ Structure Detailer: K. KULESZA Numbers		23180R
Void:	Sheet Subset: P&P Subset	t Sheets: 3 of 3	Sheet Number 18



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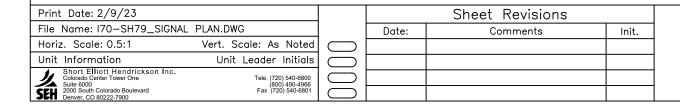
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TRAFFIC SIGNAL GENERAL NOTES

- TRAFFIC SIGNAL MATERIALS AND INSTALLATION SHALL COMPLY WITH THE "STATE OF COLORADO—STANDARD PLANS, M AND S
 STANDARDS (LATEST EDITION), THE "MANUAL OF UNIFORM TRAFFIC CONTROL DEVICES", THE "NATIONAL ELECTRIC CODE" (LATEST
 EDITION) AND ALL LOCAL ORDINANCES AND REGULATIONS THAT APPLY, EXCEPT AS NOTED ON THE PLANS OR SPECIAL PROVISIONS.
- THE CONTRACTOR SHALL BE RESPONSIBLE FOR LOCATING ALL EXISTING AERIAL AND UNDERGROUND UTILITIES AND THE PROTECTING OF THESE UTILITIES. LOCATIONS SHOWN ON THE PLANS ARE APPROXIMATE AND NOT ALL UTILITIES ARE NECESSARILY SHOWN. THE CONTRACTOR SHALL CONTACT ALL THE APPROPRIATE ENTITIES TO LOCATE UNDERGROUND FACILITIES AT LEAST 48 HOURS PRIOR TO COMMENCEMENT OF CONSTRUCTION. THE EXACT LOCATION OF EACH UTILITY SHALL BE FIELD VERIFIED BEFORE COMMENCING WORK. THE CONTRACTOR SHALL BE FULLY RESPONSIBLE FOR ANY AND ALL DAMAGES WHICH MAY OCCUR AS A RESULT OF THE CONTRACTOR'S FAILURE TO LOCATE AND PRESERVE ANY AND ALL UNDERGROUND UTILITIES. LOCATIONS OF THE TRAFFIC SIGNAL LIGHT POLES AND PEDESTAL POLE FOUNDATIONS SHALL BE ADJUSTED BY THE ENGINEER IF NECESSARY.
- 3. THE PHYSICAL FEATURES WITHIN THE LIMITS OF THE PROJECT HAVE BEEN SHOWN BASED ON THE BEST AVAILABLE INFORMATION AT THE TIME OF DESIGN. THE ENGINEER ASSUMES NO RESPONSIBILITY FOR THE ACCURACY OF THE FEATURES SHOWN. THE CONTRACTOR SHALL REVIEW AND VERIFY EXISTING PHYSICAL FEATURES AND INFORM HIMSELF OF THE CONDITIONS TO BE ENCOUNTERED DURING CONSTRUCTION.
- 4. THE CONTRACTOR IS RESPONSIBLE FOR ALL PERMITS/INSPECTIONS REQUIRED TO COMPLETE THE SCOPE OF WORK PRESENTED HEREIN.
- 5. ALL ITEMS NOT SHOWN IN THE SUMMARY OF APPROXIMATE QUANTITIES SHALL BE CONSIDERED INCIDENTAL TO THE INSTALLATION OF THE TRAFFIC SIGNAL AND WILL NOT BE MEASURED AND PAID FOR SEPARATELY. ALL QUANTITIES ARE APPROXIMATE. THE CONTRACTOR SHALL BE RESPONSIBLE FOR ALL WORK NECESSARY TO COMPLETE THE CONSTRUCTION SHOWN ON THESE PLANS. MEASUREMENT AND PAYMENT OF TRAFFIC SIGNALS CONSTRUCTION ITEMS SHALL CONFORM TO THE PROJECT SPECIFICATIONS.
- 6. PULL BOX LOCATIONS ARE APPROXIMATE. ACTUAL LOCATIONS SHALL BE VERIFIED IN THE FIELD BY THE ENGINEER. ALL PULL BOXES SHALL BE FLUSH WITH FINISHED GROUND SURFACE.
- 7. ALL PULL BOXES, INCLUDING THOSE FOR WHICH COST IS INCLUDED IN THE COST OF CONDUIT ITEMS, SHALL BE FABRICATED PER PROJECT SPECIAL PROVISION 613 PULL BOX.
- 8. THE SIGNAL SHALL NOT BE PUT IN FLASH MODE OR MADE FULLY OPERATIONAL UNTIL CDOT HAS INSPECTED AND APPROVED THE INSTALLATION AND ALL REGULATORY SIGNING AND PAVEMENT MARKINGS ARE IN PLACE. INCH PREFORMED JOINT MATERIAL SHALL BE APPLIED AROUND THE 6 INCHES OF LEVELING CONCRETE BENEATH SIGNAL POLES WHEN THE SIGNAL POLE IS INSTALLED IN EXISTING CONCRETE AND CONSIDERED INCIDENTAL TO THE WORK AND SHALL NOT BE PAID FOR SEPARATELY.
- 9. ANY DAMAGES INCURRED DURING CONSTRUCTION ACTIVITIES INCLUDING BUT NOT LIMITED TO LANDSCAPING, SIDEWALKS, CURB AND GUTTER, CONCRETE RAMPS AND SIGNS WILL BE THE RESPONSIBILITY OF THE CONTRACTOR TO BE REPAIRED OR REPLACED AS DIRECTED BY THE ENGINEER. THIS WORK WILL NOT BE PAID FOR SEPARATELY BUT SHALL BE THE RESPONSIBILITY OF THE CONTRACTOR AT HIS EXPENSE.
- 10. WASTE MATERIALS GENERATED BY THE CONTRACTOR SHALL BE DISPOSED OF BY THE CONTRACTOR AT NO ADDITIONAL COST TO THE PROJECT. IT SHALL BE THE CONTRACTOR'S RESPONSIBILITY TO OBTAIN A LEGAL DISPOSAL SITE FOR ALL UNUSABLE MATERIALS.
- 11. CONTRACTOR'S SIGNAL ELECTRICIAN IS REQUIRED TO BE ON SITE, AT A MINIMUM, DURING AM & PM PEAK HOURS FOLLOWING THE NEXT DAY A SIGNAL IS TURNED ON TO OBSERVE OPERATION AND MAKE ADJUSTMENTS AS NEEDED. THE ENGINEER MAY REQUIRE THE SIGNAL ELECTRICIAN TO BE ONSITE FOR ADDITIONAL HOURS AS DIRECTED. THIS APPLIES TO BOTH PERMANENT AND TEMPORARY INSTALLATIONS.
- 12. SHOULD CONTRACTOR ENCOUNTER WATER IN CAISSON, ANY DE-WATERING METHODS & NECESSARY PERMITS SHALL BE INCLUDED IN THE COST OF CAISSON.
- 13. A JOURNEYMAN ELECTRICIAN SHALL BE ON SITE AT ALL TIMES DURING ELECTRICAL TRAFFIC SIGNAL WORK INCLUDING INSTALLATION OF CONDUITS. THE CONTRACTOR SHALL ADHERE TO THE FOLLOWING REQUIREMENTS REGARDING TRAFFIC SIGNAL CONSTRUCTION AND MAINTENANCE PERSONNEL. CURRENT CERTIFICATES SHOWING QUALIFICATIONS SHALL BE SUBMITTED AT THE PRE—CONSTRUCTION MFFTING.
 - (1) FOR ANY WORK INSIDE THE TRAFFIC SIGNAL CABINET, SIGNAL AND SIGNAL BENCH TECHNICIANS SHALL BE MINIMUM IMSA LEVEL II CERTIFIED. THIS INCLUDES THE COMPLETION OF TRAINING IN CONSTRUCTION, CORRECTIVE MAINTENANCE, AND SIGNAL TURN-ON.
 - (2) FIELD TECHNICIAN/ELECTRICIAN OR TRAFFIC SIGNAL BENCH TECHNICIAN/SIGNAL TECHNICIAN IS REQUIRED. AN IMSA LEVEL II TRAFFIC SIGNAL ELECTRICIAN SHALL BE ON THE JOB SITE AT ALL TIMES THAT SIGNALIZATION WORK IS TAKING PLACE TO ENSURE PROPER CONSTRUCTION.
 - A MAXIMUM RATIO OF FOUR IMSA LEVEL I TO ONE IMSA LEVEL II WILL BE ALLOWED FOR WORK EXTERNAL TO THE SIGNAL CABINET.THE UNITED STATES DEPARTMENT OF LABOR BUREAU OF APPRENTICESHIP AND TRAINING MAY BE SUBSTITUTED FOR THE IMSA LEVEL I TRAFFIC SIGNAL ELECTRICIAN REQUIREMENT.
- 14. ITEM 613—10000, WIRING (1 LUMP SUM), SHALL INCLUDE ALL NECESSARY WIRING WORK, NOT OTHERWISE INCLUDED IN AN INDIVIDUAL PAY ITEM, REQUIRED TO PROVIDE A COMPLETE AND FULLY FUNCTIONAL TRAFFIC SIGNAL SYSTEM.
- 15. THE LOCATION OF TRAFFIC SIGNAL EQUIPMENT INCLUDING CONTROLLER CABINETS, POLES, AND PULL BOXES WITHIN CDOT ROW SHALL BE FIELD VERIFIED WITH TONY REED, CDOT REGION 1 TRAFFIC SIGNALS/RAMP METERING, AT 720-737-6807 AND TONY.REED@STATE.CO.US PRIOR TO CONSTRUCTION. SIGNAL DETECTION SHALL BE FIELD VERIFIED WITH THE VENDOR AND TONY REED PRIOR TO CONSTRUCTION.

TRAFFIC SIGNAL GENERAL NOTES (CONT.)

- 16. OPEN EXCAVATIONS SHALL NOT BE ALLOWED UNPROTECTED WHEN CONSTRUCTION WORK IS NOT IN PROGRESS (INCLUDING OVERNIGHT, WEEKENDS AND HOLIDAYS). METHOD(S) OF PROTECTING EXCAVATIONS (IE METAL PLATES OR CONCRETE BARRIER) FROM VEHICLES AND PEDESTRIANS SHALL BE APPROVED BY THE ENGINEER. THE COST OF PROTECTING EXCAVATIONS WILL NOT BE MEASURED AND PAID FOR SEPARATELY BUT SHALL BE INCLUDED IN THE WORK.
- 17. TWO OR MORE WEEKS PRIOR TO THE START OF CONSTRUCTION, THE CONTRACTOR SHALL SUBMIT TEMPORARY PHASING AND TIMING SIGNAL PLANS TO THE ENGINEER FOR APPROVAL.
- 18. UPON COMPLETION OF THE WORK, THE CONTRACTOR SHALL SUPPLY 2 SETS OF RECORD DRAWINGS, CORRECTED PLANS AND ANY OTHER ADDITIONAL DATA REQUIRED BY THE ENGINEER TO THE ENGINEER.
- THE CONTRACTOR SHALL PROVIDE CDOT WITH AT LEAST FOUR (4) SETS OF EQUIPMENT SPECIFICATIONS/DESCRIPTIONS AND OBTAIN APPROVALS PRIOR TO ORDERING THE EQUIPMENT.
- 20. ALL MANUALS, INSTALLATION GUIDES AND ASSOCIATED EQUIPMENT SHALL BE PROVIDED TO THE ENGINEER AT TIME OF INSPECTION.
- 21. CONTROLLER CABINET SHALL BE AS SHOWN ON THE PLANS AND SHALL BE INCLUDED IN THE COST OF THE CONTROLLER. THE CONTROLLER CABINET SHALL BE MOUNTED ON A PREFORMED CONCRETE BASE. LOAD SWITCHES SHALL INDICATE INPUT AND OUTPUT THE UNINTERRUPTIBLE POWER SUPPLY (UPS) SHALL BE PROVIDED TO RUN SIGNAL FOR 2 HOUR IN ALL PHASES, AND FLASH UP TO FOUR ADDITIONAL HOURS.
- 22. CAISSON LOCATIONS SHALL BE MARKED, POTHOLED IF NECESSARY FOR CONFLICTING UTILITIES, AND FIELD VERIFIED BY THE PROJECT ENGINEER PRIOR TO ORDERING MAST ARMS. 20 HOURS OF POTHOLING IS ESTIMATED FOR THIS PROJECT.
- 23. THE CONTRACTOR SHALL OBTAIN AN ELECTRICAL PERMIT FROM THE COLORADO STATE ELECTRICAL BOARD (DORA) FOR ALL ELECTRICAL AND TRAFFIC SIGNAL WORK.
- 24. THE CONTRACTOR IS RESPONSIBLE FOR PROVIDING AND MAINTAINING ADEQUATE TRAFFIC CONTROL THROUGHOUT THE PROJECT, INCLUDING PROPER TRAFFIC CONTROL DEVICES AND PERSONNEL. TRAFFIC CONTROL IS TO BE IN ACCORDANCE WITH THE MANUAL ON UNIFORM TRAFFIC CONTROL DEVICES (MUTCD).
- 25. ALL SIGNAL DETECTION SHOWN ON PLANS IS FOR ILLUSTRATIVE PURPOSES ONLY. ONE STOP BAR DETECTION UNIT AND THREE ADVANCE DETECTION UNITS ARE ESTIMATED.
- 26. TRAFFIC SIGNAL POLES SHALL BE A MINIMUM OF 40' IN HEIGHT FROM THE FINISHED GRADE. TRAFFIC SIGNAL POLES SHALL BE HOT DIP GALVANIZED STEEL.
- 27. FIRE PREEMPTION UNITS SHALL BE FURNISHED, TESTED, AND APPROVED BY THE LOCAL FIRE AUTHORITY.
- 28. ALL SIGNAL EQUIPMENT SHALL BE VERIFIED WITH CDOT BEFORE INSTALLATION.





			I-70 EB RAMPS & SH 79			
CONTRACT ITEM NO.	CONTRACT ITEM DESCRIPTION	UNIT	NE	SE	sw	TOTAL QUANTITY
TIEM NO.			QTY	QTY	QTY	
503-00036	Drilled Shaft (36 Inch)	LF	19	19	19	57
613-00206	2 Inch Electrical Conduit (Bored)	LF		90	95	185
613-00306	3 Inch Electrical Conduit (Bored)	LF		180	190	370
613-01200	2 Inch Electrical Conduit (Plastic)	LF	10	10	25	45
613-01300	3 Inch Electrical Conduit (Plastic)	LF	20	20	30	70
* 613-07199	Pull Box (Install Only)	EACH	1	1	1	3
613-10000	Wiring	LS				1
613-13000	Luminaire (LED) (Special)	EACH	1	1	1	3
613-80130	Service Meter Cabinet	EACH			1	1
614-00011	Sign Panel (Class I)	SF	9		9	18
614-00029	Sign Panel (Class II) (Install Only)	EACH		1		1
614-70337	Traffic Signal Face (12-12-12) (Install Only)	EACH	4	4	3	11
614-72855	Traffic Signal Controller Cabinet	EACH			1	1
614-72866	Fire Preemption Unit and Timer	EACH	2	1		3
01170007	Microwave Vehicle Radar Detector (Stop Bar Detection)	EACH	1	1	1	_
614-72887	Microwave Vehicle Radar Detector (Advanced Detection)	EACH	1		1	5
614-81301	Traffic Signal-Light Pole (1 Mast Arm) (Install Only)	EACH	1	1	1	3
614-86248	Traffic Signal Controller (Type 2070LC)	EACH			1	1
614-86800	Uninterrupted Power Supply	EACH			1	1
614-87320	Closed Circuit Television	EACH		1		1

*PULL BOXES ARE TYPE 4 UNLESS NOTED


Print Date: 2/9/23		
File Name: I70-SH79_SIGNAL	PLAN.DWG	
Horiz. Scale: 0.5:1	Vert. Scale: As Noted	
Unit Information	Unit Leader Initials	
Short Elliott Hendrickson Inc. Colorado Center Tower One Suite 6000 SEH 2000 South Colorado Boulevard Denver, CO 80222-7900	Tele. (720) 540-6800 (800) 490-4966 Fax (720) 540-6801	

		Sheet Revisions	
	Date:	Comments	Init.
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As Constructed	TRAFFIC SIGNAL TABULATION Project		Project No./Code
No Revisions:	INAFFIC SIGNA	STU 0704-248	
Revised:	Designer: A. MARQUEZ Structure Detailer: M. WAGNER Numbers		23180R
Void:	Detailer: M. WAGNER Sheet Subset: SIGNAL	Subset Sheets: 2 of 6	Sheet Number 23





LEGEND

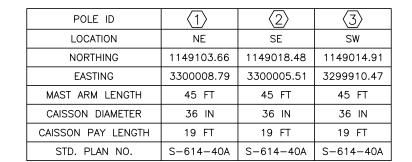TRAFFIC SIGNAL CONTROLLER & CABINET

PULL BOX (TYPE 4 UNLESS NOTED)

EMERGENCY VEHICLE PREEMPTION (EVP)

LUMINAIRE

SIGNAL HEAD

MAST ARM (LENGTH AS SPECIFIED)

сст∨⊲

CLOSED CIRCUIT TELEVISION

UNDERGROUND CONDUIT

SIGNAL HEAD WITH BACKPLATE

MAST ARM MOUNTED SIGN ELECTRIC SERVICE METER CABINET

 \Box^{EM} 早

MICROWAVE VEHICLE RADAR DETECTOR

SIGN DETAILS

SH 79

D3-1 (INSTALL ONLY)





(36"x36")



R3-2 (36"x36")

SIGNAL HEAD DETAIL

2

N/A

ø1

N/A

ø5

PHASE DIAGRAM

ø2

ø6

N/A

ø3

N/A

ø7

ø4

N/A


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(1) 12'

	\circ	
,,	R	12"
,,	Y	12"




2"	(4)	12"	()
2"	G	12"	

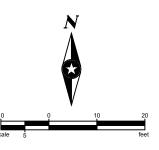


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File Name: I70—SH79_SIGNAL	PLAN.DWG		Date:	Comments	Init.
Horiz. Scale: 0.5:1	Vert. Scale: As Noted				
Unit Information	Unit Leader Initials				
Short Elliott Hendrickson Inc. Colorado Center Tower One Suite 6000	Tele. (720) 540-6800 (800) 490-4966				
2000 South Coloredo Baulayard	Fay (720) E40 6904	_	ı	l .	ı



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As Constructed	TRAFFIC SIGNAL PLAN	Project No./Code
No Revisions:	TRAFFIC SIGNAL FLAN	STU 0704-248
Revised:	Designer: A. MARQUEZ Structure	23180R
	Detailer: M. WAGNER Numbers	
Void:	Sheet Subset: SIGNAL Subset Sheets: 3 of	Sheet Number 24

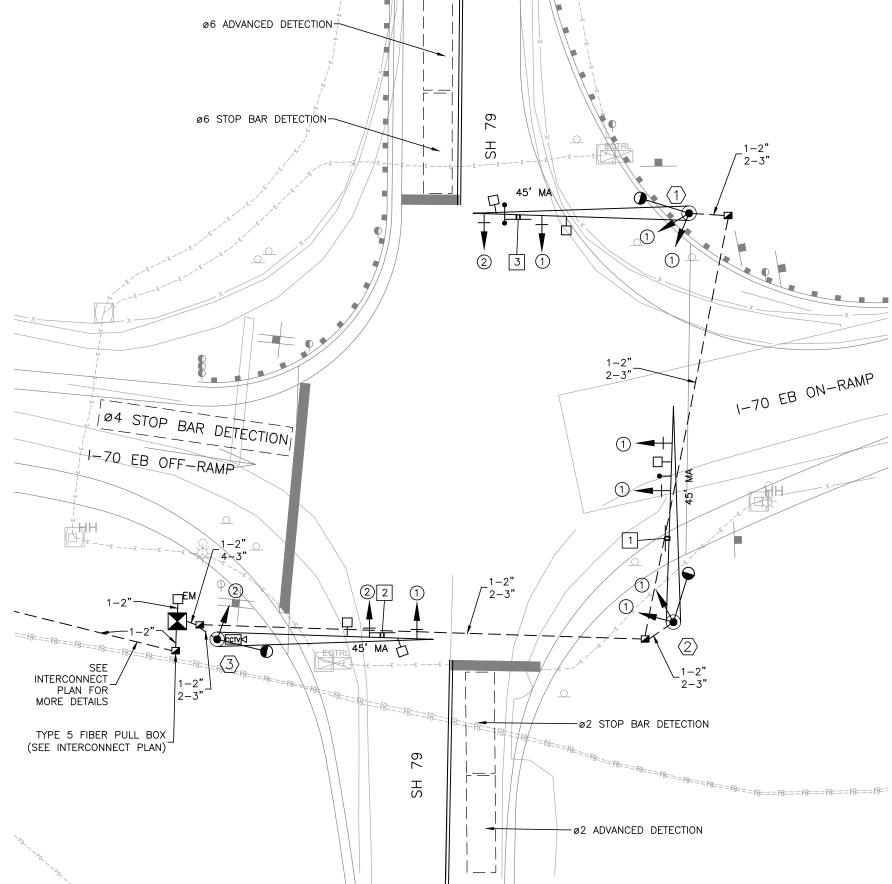



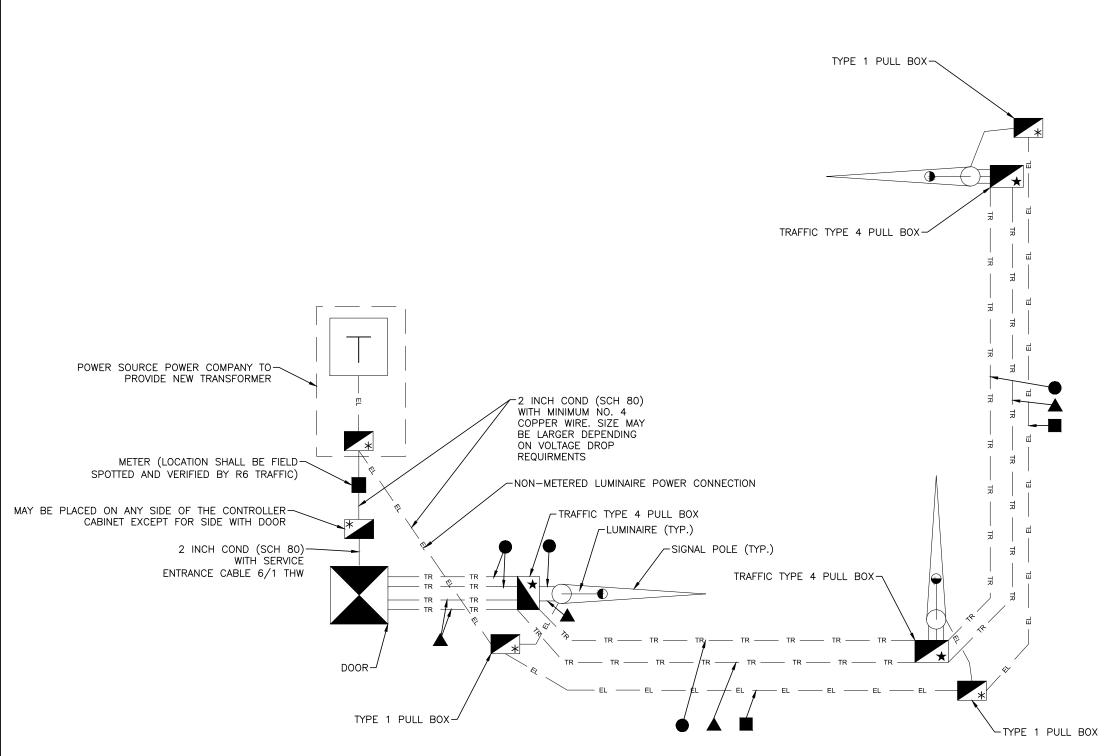

<u>NOTES</u>

- 1. See Standards M-613-1, S-614-40 AND S-614-43 for Meter, Luminaire, Pull box and Traffic Signal details.
- 2. Payment of luminaires shall be as shown on the plans.
- 3. FOR STREET LIGHT LUMINAIRES ON SPAN WIRE INSTALLATIONS—
 Two (2) number 12 AGW copper TW insulated building wires shall be installed by the contractor from the end of the luminaire arm, through the pole, along the span wire cable to the signal pole nearest the controller cabinet, through the pole, then to the power source.
- 4. FOR STREET LIGHT LUMINAIRES ON MAST ARM INSTALLATIONS

 Two (2) number 12 AGW copper TW insulated building wires shall be installed by the contractor from the end of the luminaire arm, through the pole to the pull box at the base of the signal pole. The contractor shall also install the same size wiring from the pull box at the base of the signal pole, through the conduit network, to the power source.
- All wiring for luminaires shall be included in the work and not paid for separately.
- 6. All splices at the power source shall be done by the Power Company $\,$
- 7. Wiring for street light luminaires shall be tagged per project special provision, Revision of Section 613 Electrical Conductor Identification
- 8. 10 feet of extra wire shall be coiled at the base of the power source.

LEGEND

- 3 Inch Electrical Conduit (SCH 80) for loop detector wire, pedestrian push button wire and communication lines.
- ▲ 3 Inch Electrical Conduit (SCH 80) for traffic signal field electrical wire communication lines.
- 2 Inch Electrical Conduit (SCH 80) for luminaire wiring
- Shall have the word "TRAFFIC" engraved into lid
- Shall have the word "ELECTRIC" engraved into lid. These Pull Boxes shall not be paid for separately but shall be paid for under Specification
- 613.12 of the Colorado Department of Transportation "Standard Specification for Road and Bridge Construction"


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File Name: I70—SH79_SIGNAL PLAN.DWG			Date:	Comments	Init.
Horiz. Scale: 0.5:1	Vert. Scale: As Noted				
Unit Information	Unit Leader Initials				
Short Elliott Hendrickson Inc. Colorado Center Tower One Suite 6000	Tele. (720) 540-6800 (800) 490-4966				
2000 South Colorado Boulevard	Fax (720) 540-6801				




As Constructed	TRAFFIC SIGNAL E	Project No./Code	
No Revisions:	TRAFFIC SIGNAL E	STU 0704-248	
Revised:	Designer: A. MARQUEZ	Structure Numbers	23180R
Void:	Detailer: M. WAGNER Sheet Subset: SIGNAL	Subset Sheets: 4 of 6	Sheet Number 25

	20-Oct-22		PANEL:	IVII	ETERED SEI	IVIOL	LOCATION			SEE PLAN SHE	-13
TYPE	DESCRIPTION	LOAD	BKR	CIR	Α	В	CIR	BKR	LOAD	DESCRIPTION	TYPE
Е	TRAFFIC CABINET	2880	30/2	1	3060		2	20	180	GFCI RECEPTACLE	R
Е	x	2880	Χ	3		2880	4	20		SPARE	
	SPARE		20	5	0		6	20		SPARE	
	SPARE		20	7			8			SPACE ONLY	
	SPACE ONLY			9	0		10			SPACE ONLY	
							·				
					3060	2880					

		3060	2880					
COPPER BUS SIZE:	100	GROUND:		STANDARD		NOTES:		
VOLTAGE:	240	MOUNTING:		PEDESTAL		1. TYPICAL PANEL SCHEDULE FOR NEW METERED PEDESTALS.		
PHASE:	1	ENCLOSURE:		NEMA 1				
WIRE:	2	# OF 1-POLE CIRCUITS		8				
LUGS:	MCB	CONNECTED KVA:		5.9				
BREAKER AIC RATING:	10K	CONNECTED AMPS:		24.8				
NEUTRAL:	100%	NET KVA:		NET KVA:			5.9	
FEEDER OCPD SIZE:	100	NET AMPS:			24.8			

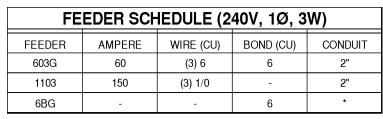

* -BOND CONDUCTOR TO 8'-0" x 5/8" COPPER GROUND ROD

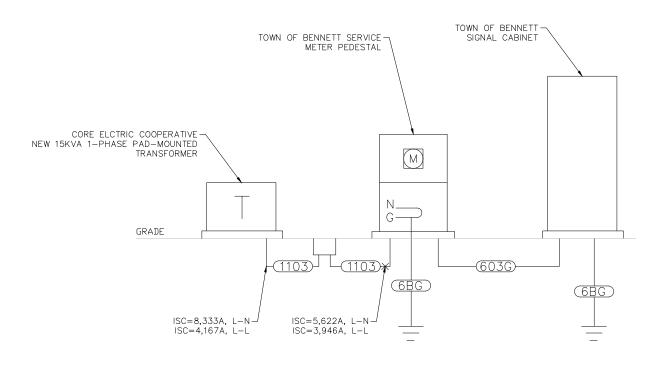


ELECTRICAL DNE-LINE DIAGRAM

SH 79 & I-70 EB RAMPS


ND SCALE

Print Date: 2/9/23		
File Name: I70-SH79_SIGNAL	PLAN.DWG	
Horiz. Scale: 0.5:1	Vert. Scale: As Noted	
Unit Information	Unit Leader Initials	
Short Elliott Hendrickson Inc. Colorado Center Tower One Suite 6000 2000 South Colorado Boulevard Debugs CO 00000 7000	Tele. (720) 540-6800 (800) 490-4966 Fax (720) 540-6801	

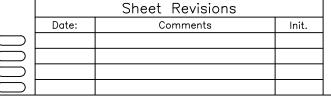



As Constructed	TRAFFIC SIGNAL 1-LINE DIAG	Project No./Code		
No Revisions:	TRAFFIC SIGNAL I-LINE DIAG			
Revised:	Designer: A. MARQUEZ Structure		23180R	
Void:	Detailer: M. WAGNER Numbers Sheet Subset: SIGNAL Subset Sheets:	5 of 6	Sheet Number	26

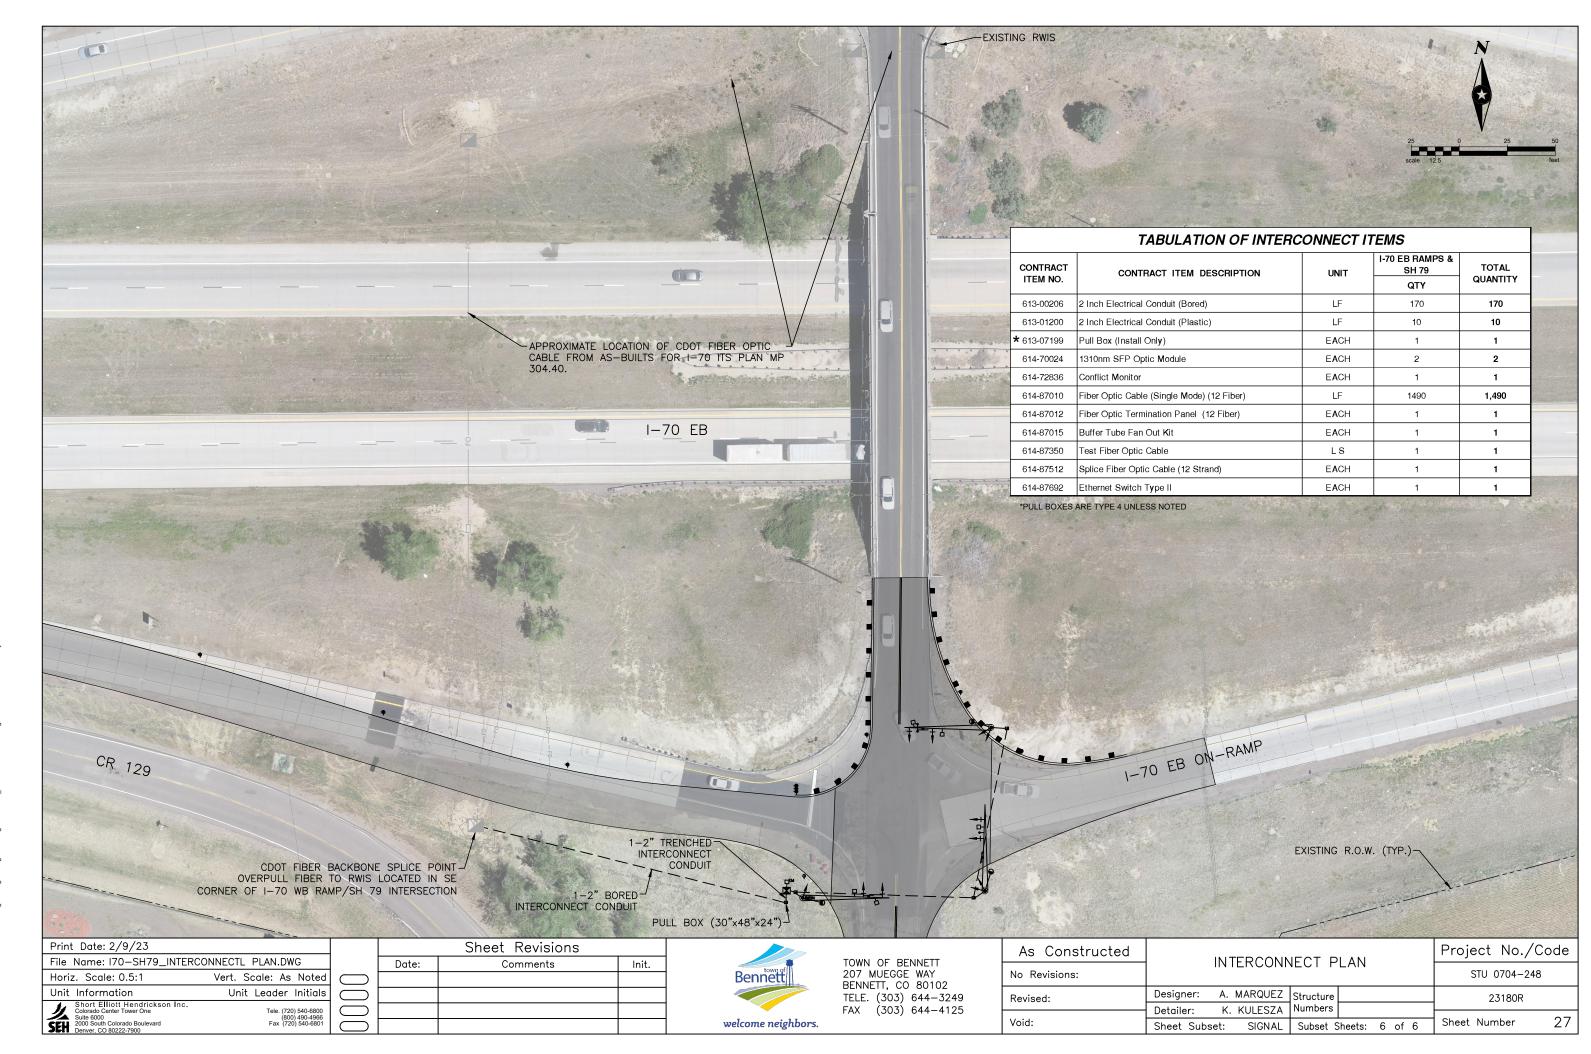

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welcome neighbors.

Revised:

Void:

23180R

Sheet Number

28

K. KULESZA Numbers


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30M4-9I

EAST

24M3-2

36M1-1

24M4-8

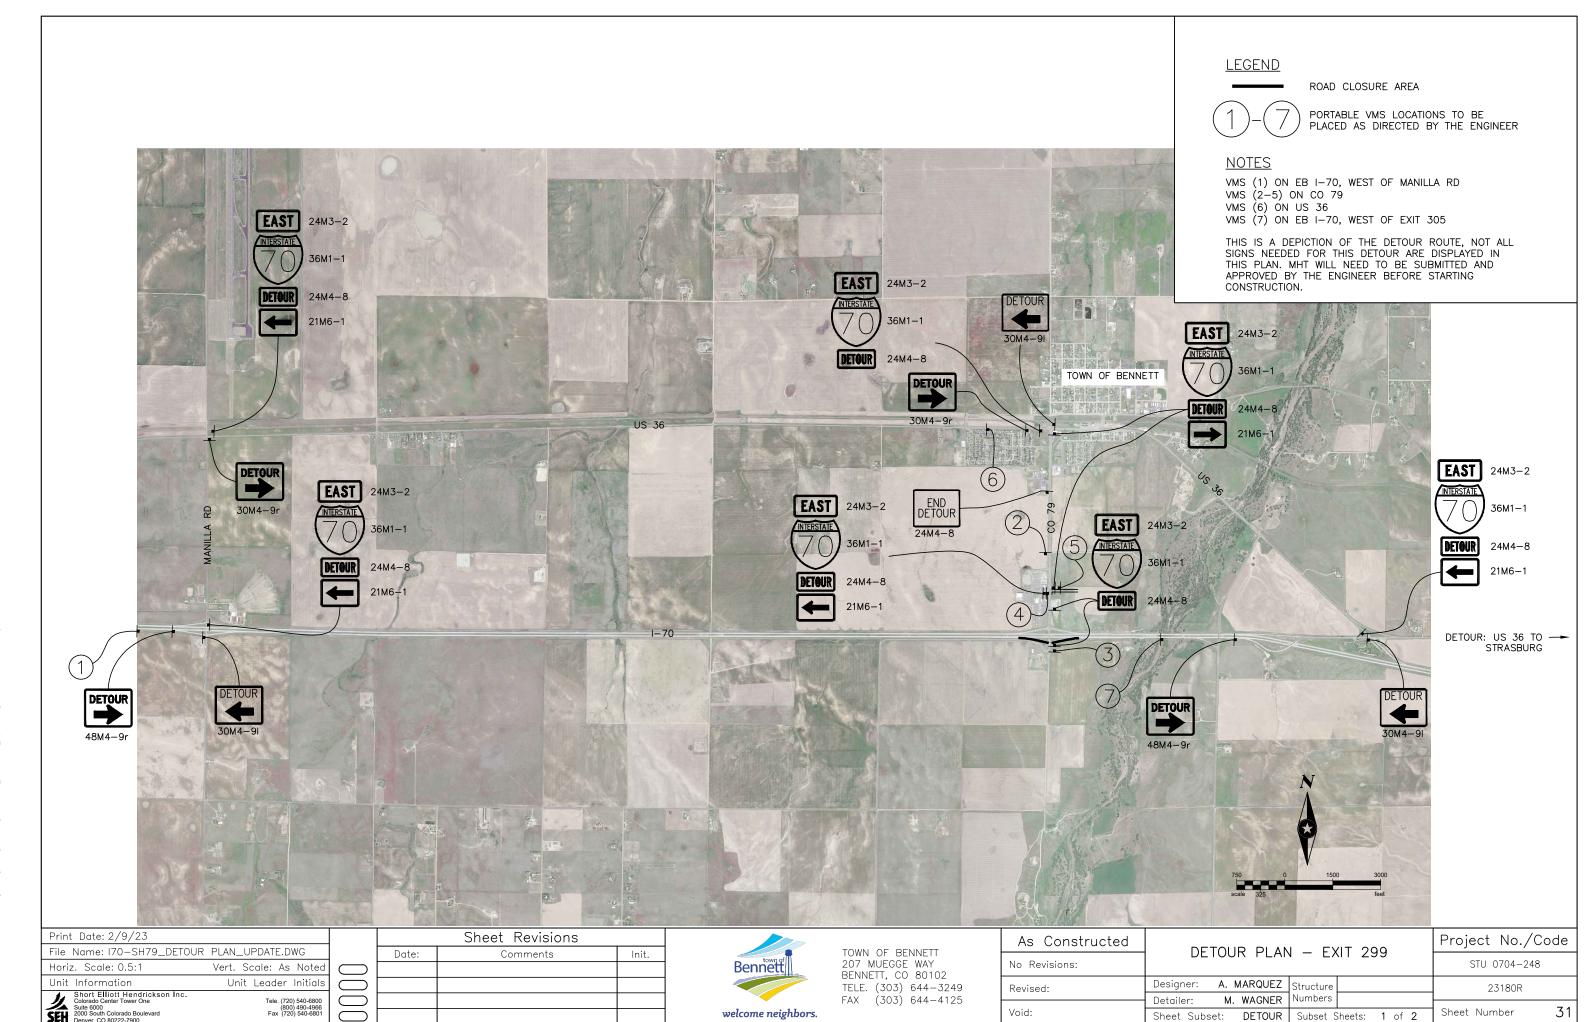LEGEND

ROAD CLOSURE AREA



PORTABLE VMS LOCATIONS TO BE PLACED AS DIRECTED BY THE ENGINEER

NOTES

EAST

EAST

TOWN OF BENNETT

24M3-2

36M1-1

VMS (1) ON EB I-70, WEST OF MANILLA RD VMS (2-5) ON SH 79 VMS (6) ON SH 36

24M3-2

36M1-1

24M4-8

21M6-1

SH 36 TO STRASBURG -

THIS IS A DEPICTION OF THE DETOUR ROUTE, NOT ALL SIGNS NEEDED FOR THIS DETOUR ARE DISPLAYED IN THIS PLAN. MHT WILL NEED TO BE SUBMITTED AND APPROVED BY THE ENGINEER BEFORE STARTING CONSTRUCTION.

Project No./Code DETOUR PLAN - EXIT 305 STU 0704-248 Designer: A. MARQUEZ Structure 23180R M. WAGNER Numbers 32 Void: Sheet Number DETOUR Subset Sheets: 2 of 2 Sheet Subset:

EASTBOUND OFF RAMP:

- 1. ADD APPROXIMATELY 5 FEET OF TEMPORARY PAVEMENT TO NORTH SIDE OF RAMP.
- 2. INSTALL TEMPORARY CONCRETE BARRIER
- 3. CONSTRUCT SOUTH SIDE OF RAMP WHILE TRAFFIC USES TEMPORARILY WIDENED NORTH SIDE.

EASTBOUND ON RAMP:

- 1. ADD APPROXIMATELY 6 FEET OF TEMPORARY PAVEMENT TO THE NORTH SIDE OF RAMP.
- 2. INSTALL TEMPORARY CONCRETE BARRIER.
- 3. CONSTRUCT SOUTH SIDE OF RAMP WHILE TRAFFIC USES TEMPORARILY WIDENED NORTH SIDE.

PHASE 2

EASTBOUND OFF RAMP:

- 1. ADD APPROXIMATELY 4 FEET OF TEMPORARY PAVEMENT TO THE SOUTH SIDE OF RAMP.
- 2. INSTALL TEMPORARY CONCRETE BARRIER.
- 3. CONSTRUCT NORTH SIDE OF RAMP WHILE TRAFFIC USES NEWLY CONSTRUCTED AND TEMPORARILY WIDENED SOUTH SIDE.

EASTBOUND ON RAMP:

- 1. ADD APPROXIMATELY 4 FEET OF TEMPORARY PAVEMENT TO THE SOUTH SIDE OF RAMP.
- 2. INSTALL TEMPORARY CONCRETE BARRIER.
 CONSTRUCT NORTH SIDE OF RAMP WHILE TRAFFIC USES NEWLY CONSTRUCTED AND TEMPORARILY WIDENED SOUTH SIDE.

ITEM NO.	ITEM	UNIT	Off-Ramp (Phase 1 & 2)	On-Ramp (Phase 1 & 2)	тот
304-06000	AGGREGATE BASE COURSE	TON	158	55	213
621-00450	DETOUR PAVEMENT	SY	531	182	713
627-00001	PAVEMENT MARKING PAINT (TEMPORARY)	GAL	10	3	13
630-80370	BARRIER (TEMPORARY)	LF	320	144	464


TEMPORARY WIDENING SUMMARY

Print Date: 2/9/23	
File Name: I70-SH79_DES_C	ONST-PHASING.DWG
Horiz. Scale: 0.5:1	Vert. Scale: As Noted
Unit Information	Unit Leader Initials
Short Elliott Hendrickson Inc. Colorado Center Tower One Sulte 6000 2000 South Colorado Boulevard	Tele. (720) 540-6800 (800) 490-4966 Fax (720) 540-6801


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Date:	Comments	Init.



As Constructed	CONSTRUCTI	Project No./Code		
No Revisions:	NO	NOTES		
Revised:	Designer: A. MARQUEZ	Structure	23180R	
	Detailer: K. KULESZA	Numbers		
Void:	Sheet Subset: PHAS	Subset Sheets: 1 of 3	Sheet Number 33	

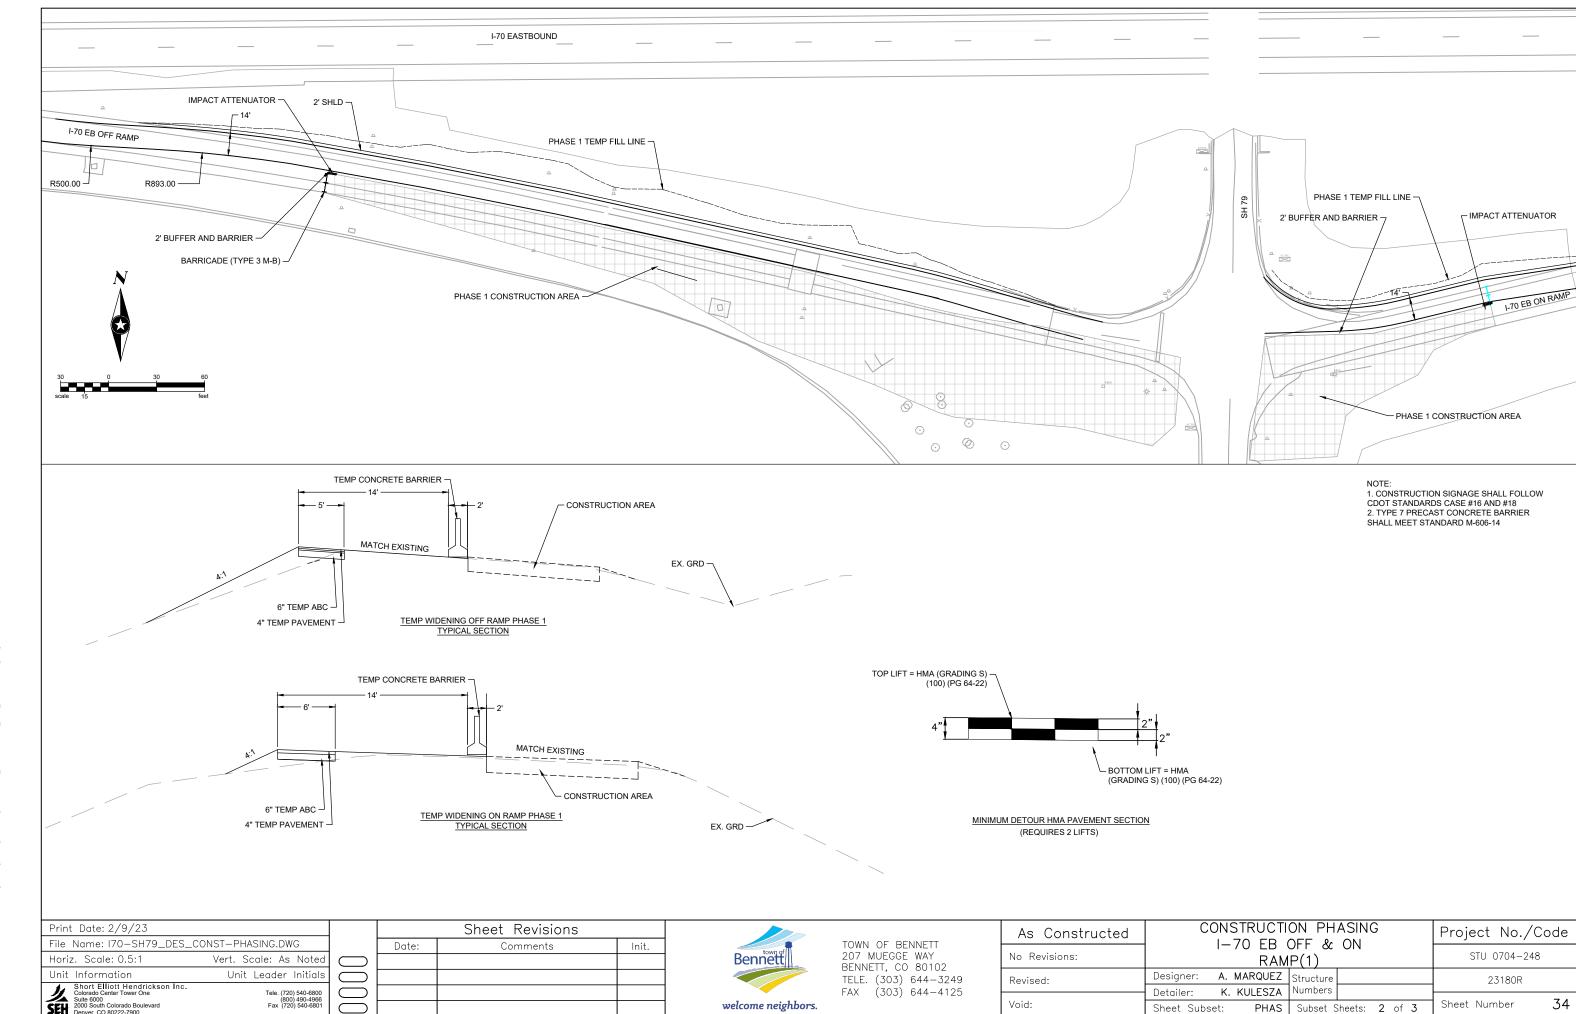

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SWMP TEMPLATE (PLAN SHEETS) FOR PROJECTS WITH LESS THAN 1 ACRE OF DISTURBANCE (5/6/2021)

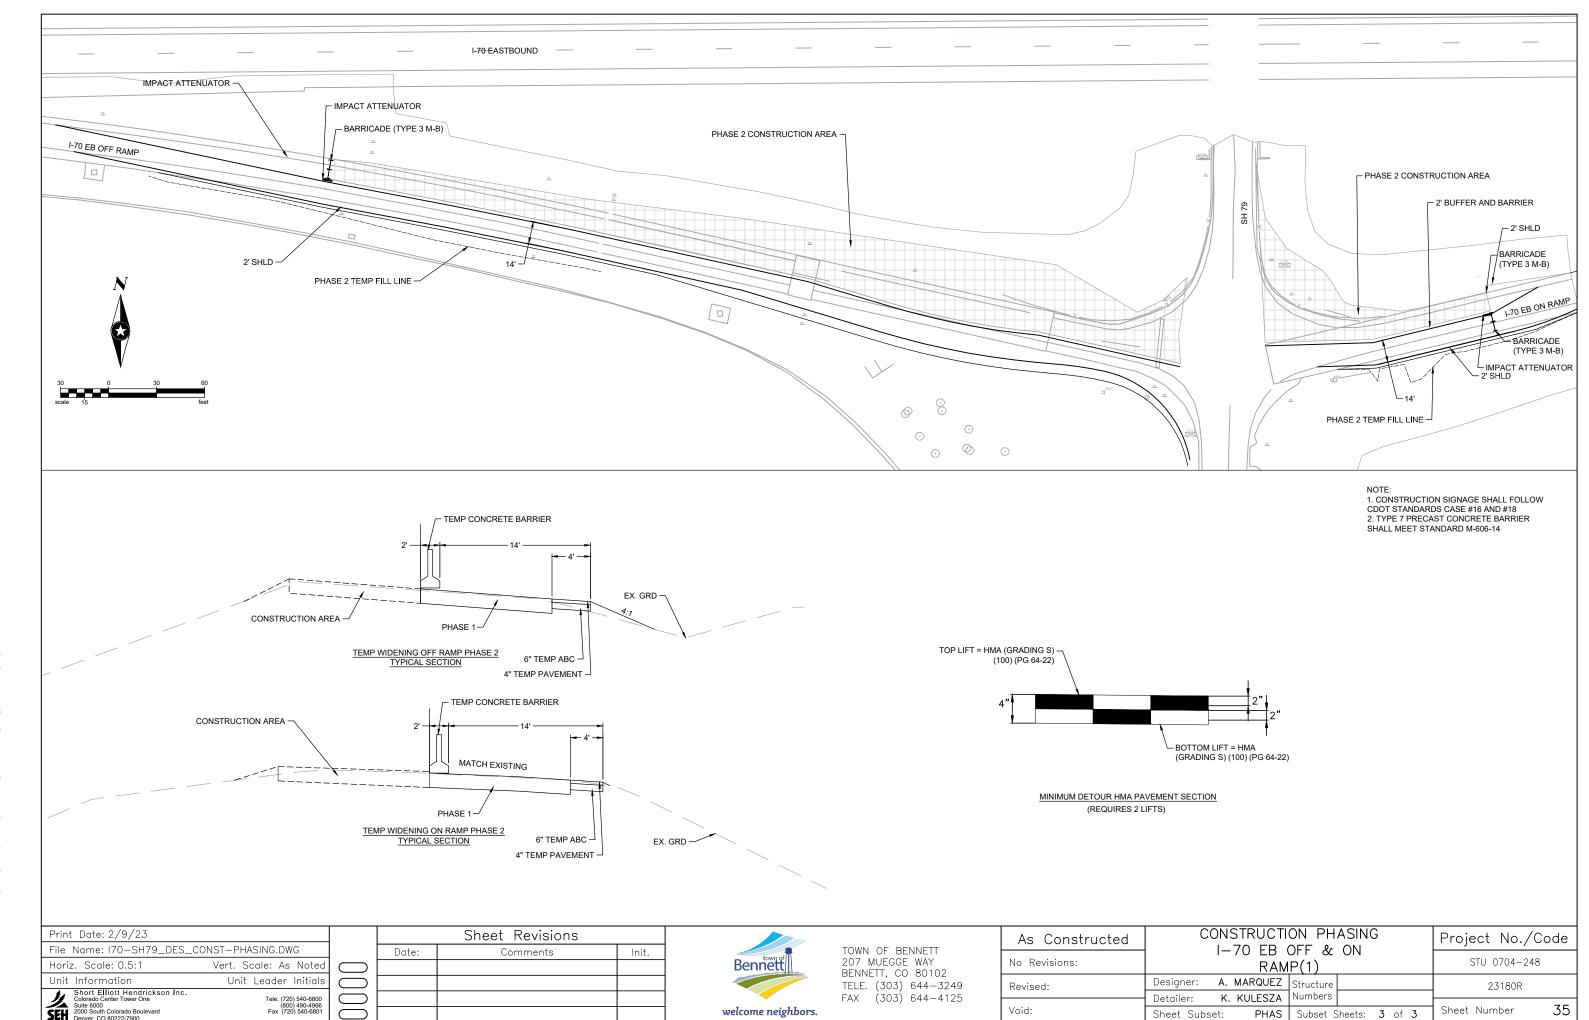1. SITE DESCRIPTION

The Contractor shall comply with all CDOT contractual requirements. The SWMP Administrator for Construction shall update to reflect current project site conditions.

1. <u>PROJECT SITE LOCATION:</u> Location or address of construction office: I-70 Eastbound Ramps and SH 79 in Bennett, CO.

B. PROJECT SITE DESCRIPTION:

This interchange and intersection improvement project includes re-aligning the eastbound exit ramp and installing a new signal at the intersection. Additionally, this project includes installing a new storm drain system to collect the runoff in this area. Minor grading will be required on the sides of the re-aligned exit ramp. This project is designed to be incorporated in a larger interchange improvement project that will see the SH 79 bridge over I-70 being replaced and widened.

C. <u>PROPOSED SEQUENCING FOR MAJOR CONSTRUCTION ACTIVITIES:</u> clearing and grubbing, grading, drainage, and excavation.

D. ACRES OF DISTURBANCE:

- 1. Total area of construction site (LOC): 1.31 acres
- 2. Total area of proposed disturbance (LDA): 0.64 acres
- 3. Total area of seeding: 0.60 acres
- E. <u>EXISTING SOIL DATA</u> Weld-Deertail complex, 0 to 3 percent slopes (4.5%), Weld-Deertail silt loams, 0 to 3 percent slopes (95.5%)

Data Source(s): %) https://websoilsurvey.sc.egov.usda.gov/App/HomePage.htm

F. EXISTING VEGETATION, INCLUDING PERCENT OF VEGETATIVE COVER: During design, the SWMP Administrator for Design in consultation with the Engineer will determine if the SWMP Administrator for Design or the SWMP Administrator for Construction will conduct the Vegetation Transects. If the site is disturbed, an Adequate Reference Site(s) may be utilized, refer to the permit.

Pre-Construction Date of survey:	Percent Existing Vegetativ	ve Cove	er:
Description of existing vegetation:			
Method for determining percent vegetative	cover:		
			_

Include a map or table showing transect locations, photos documenting pre-Construction vegetative cover, and methodology used to determine existing vegetative cover to SWMP tab 17:

Post-Construction Date of survey: ______ Percent Vegetative Cover: ______ Description of vegetation:

The method used to determine pre-construction percent cover shall be used to determine post construction percent cover.

Include map or table showing transect locations, photos documenting post-Construction vegetative cover, and methodology used to determine existing vegetative cover to SWMP tab 17:

2. STORMWATER MANAGEMENT CONTROLS FOR FIRST CONSTRUCTION ACTIVITIES

THE CONTRACTOR SHALL PERFORM THE FOLLOWING:

A. POTENTIAL POLLUTANT SOURCES

- 1. Refer to Potential Pollutant Sources in SWMP Section 4A. Evaluate, identify and describe all potential sources of pollutants at the site in accordance with subsection 107.25 and place any Control Measures required to contain potential pollutants.
- B. OFFSITE DRAINAGE (RUN ON WATER)
 - 1. Place Control Measures to address run-on water in accordance with subsection 208.03.
- C. CONSTRUCTION DEWATERING:

1. Obtain a CDPS Dewatering Permit from CDPHE if conditions of their Low Risk Guidance for Discharges of Uncontaminated Groundwater to Land are not met; see subsections 107.02 and 107.25.

Refer to CDPHE Low Risk Discharge Guidance Document of Uncontaminated Groundwater to Land. https://www.colorado.gov/pacific/sites/default/files/WQ%20LOW%20RISK%20GW.pdf

D. VEHICLE TRACKING CONTROL

1. Control Measures shall be implemented in accordance with subsection 208.04.

E. PERIMETER CONTROL

- 1. Perimeter control shall be established as the first item on the SWMP to prevent the potential for pollutants leaving the construction site boundaries, entering the stormwater drainage system, or discharging to state waters
- 2. Perimeter control may consist of berms, silt fence, erosion logs, existing landforms, or other Control Measures as approved.

3. QUALIFIED STORMWATER MANAGERS:

A. <u>SWMP ADMINISTRATOR FOR DESIGN</u>: CDOT Certified Individual responsible for developing SWMP Plan Sheets and SWMP Site Maps during the design phase.

Name/Title	Contact Information	Certification #
Katie Croell	303-586-5814	A34F8036
Engineer	kcroell@sehinc.com	

2. <u>SWMP ADMINISTRATOR FOR CONSTRUCTION</u>: (As defined in Subsection 208) The Contractor shall designate a SWMP Administrator for Construction. The SWMP Administrator for Construction shall become the operator for the SWMP and assume responsibility for all design changes to the SWMP implementation and maintenance in accordance to 208.03, the SWMP shall remain the property of CDOT. The SWMP Administrator for Construction shall be responsible for implementing, maintaining and revising SWMP, including the title and contact information. The activities and responsibilities of the SWMP Administrator for Construction shall address all aspects of the project's SWMP. (Update the information below for each new SWMP Administrator for Construction) (Copy of TECS Certification must also be included in the SWMP.)

Name/Title	Contact Information (phone & email)	TECS Certification #	Start Date	Engineer Approval

- 3. <u>PERMANENT STABILIZATION SUBJECT MATTER EXPERT:</u> This qualified individual will be either a Regional Environmental Staff member, or an Independent Contractor Controller (Independent Assurance Program). This expert is a project team leader responsible for ensuring project adherence to requirements of the 207 and 212 Project Special Provisions as follows, and will be available for questions regarding permanent stabilization requirements.
 - 1. Review the Topsoil Management Plan and the Permanent Stabilization Site Maps.
 - 2. Attend the Environmental Pre-construction Conference.
 - 3. Coordinate the Site Pre-vegetation Conference.
 - 4. Review and recommend approval of products.
 - 5. Review and recommend approval of the Quantities Verification Prerequisite.
 - 6. Attend the Substantial Landscape Completion Walkthrough.
 - 7. Attend the Final Landscape Completion Walkthrough.

Name/Title	Contact Information [phone & email]

4. DURING CONSTRUCTION

The SWMP should be considered a "living document" that is continuously reviewed and modified. During construction, the following items shall be added, updated, or amended as needed by the Contractor in accordance with Section 208

Print Date: 2/9/23			Sheet Revisions	
File Name: I70-SH79_SWMP.DWG		Date:	Comments	Init.
Horiz. Scale: 0.5:1	Vert. Scale: As Noted			
Unit Information	Unit Leader Initials			
Short Elliott Hendrickson Inc. Colorado Center Tower One Suite 6000	Tele. (720) 540-6800 (800) 490-4966			
SEH 2000 South Colorado Boulevard Denver, CO 80222-7900	Fax (720) 540-6801			



As Constructed	STORMWATER MA	Project No./Code	
No Revisions:	STORMWATER MA	STU 0704-248	
Revised:	Designer: A. MARQUEZ	Structure Numbers	23180R
Void:	Detailer: M. WAGNER Sheet Subset: SWMP	Subset Sheets: 1 of 6	Sheet Number 36

- A. MATERIALS HANDLING AND SPILL PREVENTION: prior to construction commencing the Contractor shall submit a Spill Prevention, Control and Countermeasure Plan, see subsection 208.06. Materials handling shall be in accordance with subsection 208.06.
- B. OTHER CDPS PERMITS: List applicable CDPS permits associated with the permitted site and activities.
- C. STOCKPILE MANAGEMENT: shall be done in accordance with subsections 107.25 and 208.07
- D. CONCRETE WASHOUT: Concrete wash out water or waste from field laboratories and paving equipment shall be contained in accordance with subsection 208.05.
- E. SAW CUTTING: shall be done in accordance with subsections 107.25, 208.04, 208.05
- F. STREET SWEEPING: shall be done in accordance with subsection 208.04

5. CONTROL MEASURE MAINTENANCE

A. Maintenance shall be in accordance with subsection 208.04 (f).

6. INTERIM AND PERMANENT STABILIZATION

The Contractor shall comply with all interim stabilization and permanent stabilization requirements in accordance with subsection 208.04(e).

A. SEEDING PLAN

The following seed mix(es) and rates are for drill seeding method as shown on the Permanent Stabilization Site Maps shall be used:

COMMON NAME	BOTANICAL NAME LB	
Sideoats gramma	Bouteloua Curtipendula var. Vaughn	2.7
Blue grama	Bouteloua Gracilis var. Lovington	1.1
Mountain brome	Bromus Marginatus var. Witmar	5.0
Canada Wildrye	Elymus Canadensis var. Native	3.0
Slender Wheatgrass	Elymus Trachycaulus var. An Louis	2.2
Western Wheatgrass	Pascropyrum Smithii var. Arriba	4.8
Beardless Wheatgrass	Pseudoroegneria Spicata spp. Inermis, var. Bromar	4.5
TOTAL		23.3

B. SEEDING APPLICATION: The following seeding methods shall be used for all areas which are not surfaced and as shown on the Permanent Stabilization Site Maps. Soil compaction shall be minimized for areas where permanent stabilization will be achieved through vegetative cover.

SEEDING METHOD (subsection 212.05)	ACRE
Seeding (Native) Drill, CDOT Pay Item 212-00706	0.60
TOTAL	0.60

The Contractor shall provide the location of where seed is stored and access to stored seed locations to the Engineer. Seed stored by the Contractor for longer than 30 days will be rejected.

- C. MULCHING APPLICATION: Apply a minimum of 2 tons of certified weed free hay or 2 1/2 tons of certified weed free straw per acre and in accordance with Section 213, and mechanically crimp it into the soil in combination with an organic mulch tackifier.
 - 1. Prior to winter shutdown or the summer seeding window closure: Uncompleted slopes shall be mulched with 2 tons of mulching (weed free) per acre, mechanically crimped into the topsoil in combination with an organic mulch tackifier in accordance with subsections 208 and 213.
- D. SPECIAL REQUIREMENTS:

1. Soil amendments, seedbed preparation, and permanent stabilization mulching shall be accomplished

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is not mulched with permanent stabilization mulch within four working days, the Contractor shall complete interim stabilization methods in accordance with subsection 208.04(e) at no additional cost to the Department.

2. Permanent stabilization mulching shall be accomplished within 24 hours of hydraulic application of native seed.

The Contractor shall submit a proposed Permanent Stabilization Phasing Plan to the Engineer for approval showing how the SWMP Permanent Stabilization Plans will be implemented to minimize damage to seeded areas.

E. SOIL AMENDMENT REQUIREMENTS: Minimum amendment material requirements for all disturbances to receive seeding (native).

0.60 Total Acres of Seeding (Native) Drill

Orill 706	Pay Item	Description	Amount/Acre	Units	Total For This Method
ve)I	212-00700	Organic Fertilizer High N	300	Pounds	180
(Native)Drill n 212-00706	212-00701	Compost (Mechanically Applied)	65	CY	39
ling (Item	212-00703	Humate	200	Pounds	120
Seeding Pay Item	212-00704	Mycorrhizae	8	Pounds	5
ν. π	212-00705	Elemental Sulfur	100	Pounds	60

F. SOIL RETENTION COVERING: On slopes and ditches requiring a blanket or turf reinforcement mat (trm), the blanket/trm shall be placed in lieu of mulch and mulch tackifier and placed after seeding (native). See SWMP Site Map for blanket/trm locations.

G. Permanent Stabilization Application Under Structures: Under structures shade patterns should be considered and the use of Median Cover Material (Stone) or other stabilized options with an approved Project Special Provision should be used. See SWMP Site Map for locations.

H. RESEEDING OPERATIONS/CORRECTIVE STABILIZATION:

Prior to partial acceptance.

- 1. All seeded areas shall be reviewed by the SWMP Administrator for Construction and or Engineer for bare soils caused by surface or wind erosion. Bare areas caused by surface or gully erosion, blown away mulch, etc. shall be re-graded, seeded, and have the designated mulching applied as necessary, at no additional cost to the project.
- 2. The Contractor shall maintain seeding/mulch/tackifier/blanket/TRM, mow to control weeds or apply herbicide to control weeds in the seeded areas until Partial Acceptance of the stormwater construction work.

7. PRIOR TO PROJECT FINAL ACCEPTANCE

- A. When directed by the Engineer, removal and disposal of temporary control measures shall be included in the cost of work.
- B. At the end of the project, all ditch checks shall consist of either temporary erosion logs (or equivalent) or permanent riprap.
- C. All storm drains shall be cleaned prior to the Final Acceptance of the project. If required, include work in 202-04002 Clean Culvert.
- D. Refer to Specification 208.10 for Items to be completed prior to requesting partial acceptance of water quality work

8. NARRATIVES:

Control Measure Matrixes During Construction:

- 1. Control measure narratives have been included for the CDOT Standard Specifications and Standard Plan M-208 and M-216 along with any non-standard control measures approved during the design process. If a Non-Standard Control Measure not included in the SWMP is proposed and approved by the Engineer the SWMP Administrator for Construction shall do the following: Place an "X" in the column for non-standard and complete a Non-Standard Control Measure Specification and Narrative covering the what, when, where and why the control measure is being used shall be add to the SWMP. The appropriate "X" shall also be added to the implementation phase(s).
- 2. The SWMP Administrator for Construction shall place an "X" in the column In Use On Site when the control measure has been installed.
- 3. A "B" in the Initial Activities Column indicates that the control measure shall be installed **before** construction activity starts. Locations and quantities will be discussed during the Environmental Pre-Construction Conference with the Regional Water Pollution Control Manager.

STRUCTURAL Control Measures that may be potentially used on the project for erosion and sediment control; practices may include, but are not limited to:

				CONTROL MEAS	URE IMPLEMEN	TATION PHASE
APPLICATION, CONTROL MEASURE	NARRATIVE	M- 208 STANDARD or "X" for NON- STANDARD	IN USE ON SITE	INITIAL ACTIVITIES	INTERIM ACTIVITIES	PERMANENT STABILIZATION
PROTECTION OF EXISTING WETLANDS Fence (plastic) and erosion logs	Fence (plastic) shall be placed in combination with erosion logs to prevent encroachment of construction traffic and sediment into state waters prior to start of construction disturbances. Fence (plastic) shall be placed adjacent to the wetlands; erosion logs shall be placed between the plastic fence and disturbance area. Logs shall be placed to direct flows away from or filter water running into wetlands from disturbance areas.					
PROTECTION OF EXISTING TREES/LANDSCAPING Fence (plastic)	Fence (plastic) shall be used in areas indicated in the plans to prevent encroachment of construction traffic and sediment for the protection of mature trees and/or existing landscaping prior to start of construction disturbances.					
CHECK DAM/DITCH CHECK Erosion log, silt berm, silt dike, rock check dam	Placed in ditches immediately upon completion of ditch grading to reduce velocity of runoff in ditch. For existing ditches, place prior to start of construction disturbances.	M-208				
Storm Drain Inlet Protection In Paved Roadways (Type 1, 2 and 3 as shown on M-208-1, sheet 5 of 11)	Manufactured storm drain inlet protection placed prior to construction disturbances as detailed in M-208-1, to protect existing inlets or immediately upon completion of new inlets to prevent sediment from entering the inlet throughout construction.	M-208				
Storm Drain Inlet Protection In Native Seed Areas (M-604 Standard Inlets Type C and D)	Erosion logs or aggregate bags placed around inlet grate to prevent sediment from entering inlet. Place prior to construction disturbances to protect existing inlets or immediately upon completion of new inlets.	M-208				
CULVERT INLET/OUTLET PROTECTION Erosion logs, aggregate bags	Placed at mouth of culvert inlets and over top of culvert at inlet and outlet where disturbance may be occurring adjacent to pipe to prevent sediment laden water from entering pipe or drainage. Place prior to start of construction disturbances.	M-208		х	х	
TYPE C, TYPE D AND TYPE 13 PROTECTION Erosion logs, aggregate bags, erosion bales	Placed around inlet grate or slope and ditch paving to prevent sediment from entering inlet. Place prior to start of construction disturbances.	M-208		В	х	
STOCKPILE PROTECTION Temporary berm, erosion logs, aggregate bags*	Placed within specified distance, in accordance with subsection 208.06, from toe to contain sediment around stockpile. *Aggregate bags are easily moved and replaced for access during the work day. Place prior to start of stockpile, increase control as stockpile increases size.	M-208				
TOE OF FILL PROTECTION Erosion logs, temporary berm, silt fence, topsoil windrow*	Place prior to slope/embankment work to capture sediment and protect and delineate undisturbed areas. *Can be used to stockpile topsoil for salvage.	M-208		Х	х	
PERIMETER CONTROL Erosion logs, silt fence, temporary berm, topsoil windrow*	Placed prior to construction commencing to address potential run-on water from off site, and to divert around disturbed area. *Can be used to stockpile topsoil for salvage.	M-208		В	Х	
SEDIMENT CONTROL/ SLOPE CONTROL Silt fence, erosion logs	Placed on the contour of a slope to contain and slow down construction runoff. Place prior to start of construction disturbances.	M-208		х	Х	
TEMPORARY SEDIMENT TRAP	Used to capture sediment laden runoff from disturbed areas < 5 acres during construction. Place prior to start of construction disturbances. Outlets that withdraw water from or near the surface may be installed when discharging from basins and impoundments.	M-208				
EMBANKMENT PROTECTION OR TEMPORARY SLOPE DRAIN	Placed as a conduit or chute to drain runoff down slope and to prevent erosion of slope.	M-208				
OUTLET PROTECTION Riprap, or approved other	Material placed as energy dissipater to prevent erosion at outlet structure.	M-601-12				

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2000 South Colorado Boulevard	Fax (720) 540-6801			



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No Revisions:	3 TORMIWATER MA	STU 0704-248	
Revised:	Designer: A. MARQUEZ		23180R
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CONCRETE WASHOUT In-ground or fabricated	Construction control, used for waste management of concrete and concrete equipment cleaning. Place prior to start of concrete activities.	M-208	х	Х	
VEHICLE TRACKING PAD	Source control, placed to prevent tracking of sediment from disturbed area to offsite surface. Place prior to start of construction disturbances.	M-208	В	х	
Engineered SEDIMENT BASIN	Constructed early in project, prior to storm sewer/ditches and in accordance with 208.05(p) to capture storm flow. Outlet structure and/or outfall shall be modified for temporary sediment control using an approved non-standard detail. Outlets that withdraw water from or near the surface shall be installed when discharging from basins and impoundments, unless infeasible				
DEWATERING (Contractor is responsible for obtaining a permit from Colorado Department of Health and Environment.)	Shall be done in such a manner to prevent potential pollutants from entering state waters.				
TEMPORARY STREAM CROSSING	Constructed over stream or drainage to prevent discharge of pollutants from construction equipment into water.				
CLEAN WATER DIVERSION	Placed to divert clean surface or ground water around disturbance area to prevent it from mixing with construction runoff.				
OTHER					

NON-STRUCTURAL Control Measures that may be potentially used on the project for erosion and sediment control; practices may include, but are not limited to: Erosion control devices are used to limit the amount of soil loss on site. Sediment control devices are designed to capture sediment on the project site.

				CONTROL MEASURE IMPLEMENTATION PHASE		
APPLICATION, CONTROL MEASURE	NARRATIVE	M- STANDARD or "For NON- STANDARD	IN USE ON SITE	INITIAL ACTIVITY	INTERIM ACTIVITIES	PERMANENT STABILIZATION
VEGETATIVE BUFFER STRIP	Finishing component for filtering sediment-laden runoff from disturbance area. Area within CDOT ROW					
Fence (plastic)	or temporary easement to be identified on SWMP prior to construction starting.					
GRADING APPLICATIONS (LANDFORM)	Existing or created landforms may be used as a control measure if they prevent sediment from entering or leaving the disturbance area. If a landform directs flow of water to a concentrated outfall point, the outfall point shall be protected to prevent erosion. Area to be identified on SWMP prior to construction starting.	M-208				
TOPSOIL MANAGEMENT STOCKPILE/SALVAGE Windrow or stockpile	Prior to any site disturbance work commencing, existing topsoil shall be scraped to a depth four inches or as specified, and placed in stockpiles or windrows. Upon completion of final grading, topsoil shall be evenly distributed over embankment to a depth of four inches or as specified.	M-208		х	х	х
SURFACE ROUGHENING / GRADING TECHNIQUES	Temporary stabilization of disturbance and to minimize wind and erosion.				Х	
SEEDING (TEMPORARY)	Temporary stabilization used for over wintering of disturbance or used to control erosion for areas scheduled for future construction.					
BONDED FIBER MATRIX or MULCHING (HYDRAULIC)	Not to be used in areas of concentrated flows, i.e. ditch lines. To be for either Interim or Permanent Stabilization placed as a surface cover for erosion control. May be used as surface cover when work is temporarily halted and as approved by the Engineer for stockpiles.					
Straw or Hay MULCH/MULCH TACKIFIER	Interim or Permanent Stabilization placed as a surface cover for erosion control and or seeding establishment. To be installed as Interim Stabilization as a surface cover when work is temporarily halted and as approved by the Engineer				х	Х
SPRAY-ON MULCH BLANKET (Not to be used in areas of concentrated flows, i.e. ditch lines.)	Interim or Permanent Stabilization placed as a surface cover for erosion control and or seeding establishment. To be installed as temporary surface cover when work is temporarily halted and as approved by the Engineer					
SEEDING PERMANENT (NATIVE)	Permanent Stabilization of disturbance and to reduce runoff and control erosion on disturbed areas.				х	Х
SOIL RETENTION BLANKET (SRB)	Permanent Stabilization of disturbance and to reduce runoff and control erosion on disturbed areas.	M-216			х	Х

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Revised:	Designer: A. MARQUEZ Detailer: M. WAGNER	Structure Numbers	23180R
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TURF REINFORCEMENT MAT (TRM)	Permanent Stabilization of disturbance and to reduce runoff and control erosion on disturbed areas. Placed in channels or on slopes for erosion control, channel liner and seeding establishment.	M-216			
Sweeping	Source control, used to remove sediment tracked onto paved surfaces and to prevent sediment from entering drainage system. Sweep daily and at the end of the construction shift as needed. Kick brooms shall not be permitted.		х	х	Х
OTHER					

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9. TABULATION OF STORMWATER QUANTITIES

1. Control Measure sediment removal and disposal shall be paid for as: 208 Removal and Disposal of Sediment (Equipment) and 208 Removal and Disposal of Sediment (Labor). All other control measure maintenance shall be included in the cost of the control measure.

PSP Spec.	Pay Item Description		Pay Unit	Initial Const.	Interim Const.	Permanent Stabilization	*Total Quantity
Х	202-04002	Clean Culvert	Each	4		1	5
	207-00700	Topsoil (Onsite)	CY			485	485
	207-00704 Subgrade Soil Preparation		SY			2909	2909
	208-00002	Erosion Log Type 1 (12 inch)	LF	150	150		300
	208-00020	Silt Fence	LF	1800			1800
	208-00046	Pre-fabricated Concrete Washout Structure (Type 1)	Each		1		1
	208-00075 Pre-fabricated Vehicle Tracking Pad 208-00103 Removal and Disposal of Sediment (Labor) 208-00105 Removal and Disposal of Sediment (Equipment)		Each	2			2
			Hour		8		8
			Hour		8		8
208-00106 Sweeping (Sediment Removal)		Hour	25	50	25	100	
	212-00706	Seeding (Native) Drill	Acre		0.90	0.60	1.50
	213-00002	Mulching (Weed Free Hay)	Acre		0.48	0.32	0.80
	213-00061	Mulch Tackifier	LB		97	65	162
	216-00201	Soil Retention Blanket (Straw/Coconut) (Biodegradable Class 1)	SY		2019	1346	3365
	217-00020	Herbicide Treatment	Hour			8	8
Х	700-70380	F/A Erosion Control	FA	0.33	0.33	0.33	1

*It is anticipated that additional control measures and control measure quantities not shown on the SWMP Site Maps shall be required on the project for unforeseen conditions and replacement of items that are beyond their useful service life, see subsections 208.03 and 208.04. Quantities for all control measures shown above are estimated, and have been increased for unforeseen conditions and normal control measure life expectancy. Quantities shall be adjusted according to the conditions encountered in the field as directed and approved by the Engineer. Payment shall be for the actual work completed and material used.

**Pay Item 208-00071 is included for anticipated maintenance of vehicle tracking pads based on the service life of the control measure in the field. The use of the material shall be directed and approved by the Engineer.

*** Using Erosion Control Management Pay Item on the project must be approved by the Regional Environmental Staff and Engineer. See 208.11 for method of measurement for the day pay unit.

**** F/A refers to CDOT's Force Account Pay Items.

10. BIOLOGICAL IMPACTS and DEWATERING

A. ENVIRONMENTAL IMPACTS:

Wetland Impacts: NO Stream Impacts: NO

Threatened and Endangered Species: No species are anticipated to be impacted by the project.

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Revised:	Designer: A. MARQUEZ	1	23180R
	Detailer: M. WAGNER	Numbers	
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B. DEWATERING:

(Not covered under the CDPHE guidance document Low Risk Discharge Guidance Discharges of Uncontaminated Groundwater to Land):


https://www.colorado.gov/pacific/sites/default/files/WQ%20LOW%20RISK%20GW.pdf

Dewatering: Refer to other environmental permits in accordance with subsection 107.02 and the permits contained in Tab 16 of the SWMP.

If groundwater does not meet water quality standards for receiving water a separate CDPS Dewatering Permit shall be obtained by the Contractor from CDPHE in accordance with subsections 107.02 and 107.25.

11.<u>NOTES</u>

- 1. EMC (or SWMP Administrator for Construction or Erosion Control Inspector) is included in the cost of the work.
- 2. Wetlands were not delineated with this project. Contractor shall protect all wetlands within the project area if needed.
- 3. Items required for miscellaneous erosion control work as directed by the Engineer will not be measured and paid for separately but shall be included in the cost of the work.

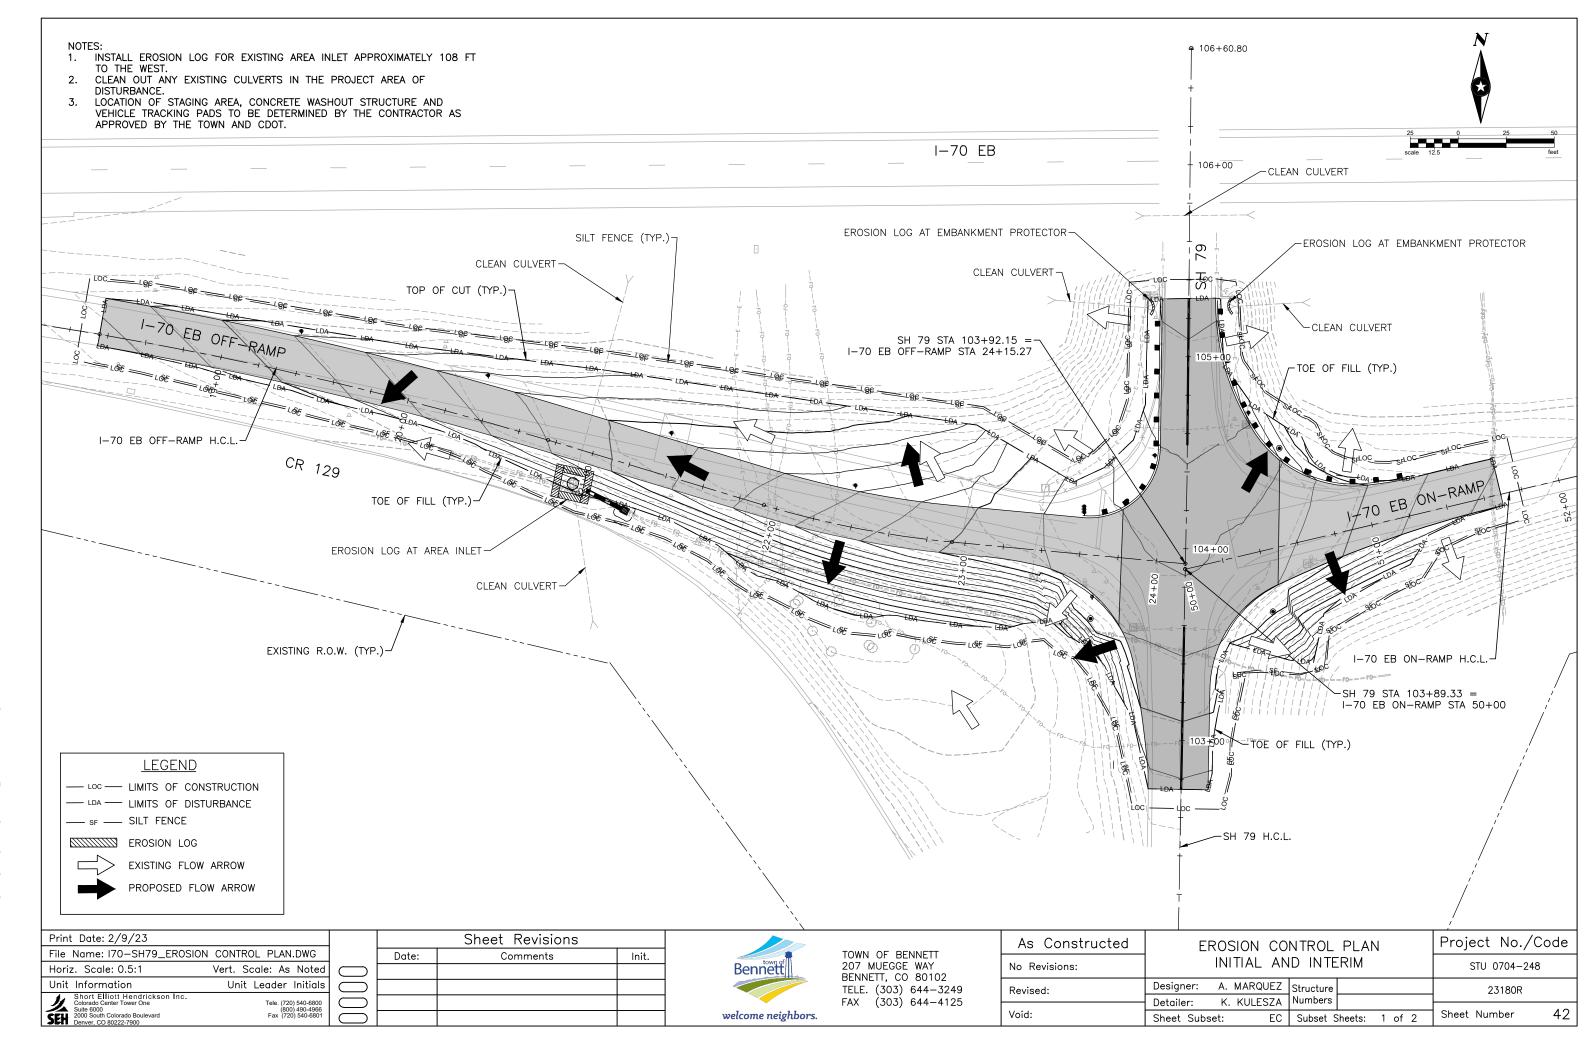

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UTILITY GENERAL NOTES

- 1. UTILITIES AS SHOWN ON THE PLAN SHEETS ARE PLOTTED FROM THE BEST AVAILABLE INFORMATION. THE CONTRACTOR'S ATTENTION IS DIRECTED TO SUBSECTION 105.11 OF THE STANDARD SPECIFICATIONS CONCERNING UTILITIES.
- 2. UTILITIES ARE DEPICTED ON THESE PLANS IN ACCORDANCE WITH THEIR ACHIEVED QUALITY LEVEL AS DEFINED IN THE AMERICAN SOCIETY OF CIVIL ENGINEER'S DOCUMENT ASCE 38 "STANDARD GUIDELINE FOR THE COLLECTION AND DEPICTION OF EXISTING SUBSURFACE UTILITY DATA." RELIANCE UPON THIS DATA FOR RISK MANAGEMENT PURPOSES DURING BIDDING DOES NOT RELIEVE THE EXCAVATOR OR UTILITY OWNER FROM FOLLOWING ALL APPLICABLE UTILITY DAMAGE PREVENTION STATUTES, POLICIES, AND/OR PROCEDURES DURING CONSTRUCTION.
- 3. THE CONTRACTOR SHALL COMPLY WITH ARTICLE 1.5 OF TITLE 9, CRS ("EXCAVATION REQUIREMENTS") WHEN EXCAVATING OR GRADING IS PLANNED IN THE AREA OF UNDERGROUND UTILITY FACILITIES. THE CONTRACTOR SHALL NOTIFY ALL AFFECTED UTILITIES AT LEAST TWO (2) BUSINESS DAYS, NOT INCLUDING THE ACTUAL DAY OF NOTICE, PRIOR TO COMMENCING SUCH OPERATIONS. THE CONTRACTOR SHALL CONTACT COLORADO 811 (FORMERLY UTILITY NOTIFICATION CENTER OF COLORADO (UNCC)) AT PHONE NO. 811 OR CO811.ORG, TO HAVE LOCATIONS OF COLORADO 811 REGISTERED LINES MARKED BY MEMBER COMPANIES. ALL OTHER UNDERGROUND FACILITIES SHALL BE LOCATED BY CONTACTING THE RESPECTIVE OWNER. UTILITY SERVICE LATERALS SHALL ALSO BE LOCATED PRIOR TO BEGINNING EXCAVATION OR GRADING.
- 4. THE CONTRACTOR SHALL BE RESPONSIBLE FOR VERIFYING THE LOCATION AND DEPTH OF ALL EXISTING UTILITIES AS NECESSARY TO ENSURE THAT THE UTILITIES WILL NOT BE IMPACTED BY CONSTRUCTION ACTIVITIES. THE CONTRACTOR SHALL COORDINATE WITH THE UTILITY OWNERS TO BE ON-SITE DURING POTHOLING. IF EXISTING UTILITIES ARE WITHIN CLOSE PROXIMITY HORIZONTALLY OR VERTICALLY TO PROPOSED INSTILLATIONS, THE CONTRACTOR SHALL CONTACT THE ENGINEER. ANY EXISTING UTILITY, WHICH IS TO REMAIN BUT IS DAMAGED AS A RESULT OF THE CONTRACTOR'S OPERATION, SHALL BE REPLACED AT THE CONTRACTOR'S EXPENSE.
- 5. CDOT UTILITY AS-CONSTRUCTED REQUIREMENTS, DATA CONTENT AND ACCURACY 1.1. ALL UTILITY INSTALLATIONS, WITHIN CDOT RIGHT OF WAY (ROW), SHALL BE COLLECTED USING CDOT'S MOBILE APPLICATION (POINTMAN). IF REQUIRED PLEASE CONTACT CDOT AT CDOTPOINTMAN@GMAIL.COM IN ORDER TO OBTAIN NEW LOGIN AND PASSWORD INFORMATION. DOWNLOAD POINTMAN MOBILE APPLICATION THROUGH THE APPLE STORE (IOS) OR GOOGLEPLAY (ANDROID). FINALLY, PLEASE WATCH THE FOLLOWING QUICK START GUIDE, THE VIDEO CAN BE FOUND AT THE FOLLOWING LINK: HTTPS://YOUTU.BE/X-TMVNK7VZW

UTILITY CONTACT LIST

UTILITY OWNER	UTILITY	CONTACT PERSON(S)	PHONE NUMBER	EMAIL
ALTERNATIVE ENERGY SOLUTIONS	FIBER	MARK RAY	303-947-4641	1.CLR.INC@GMAIL.COM
BIJOU TELEPHONE COOP	FIBER / PHONE	BRIAN CREVELING	303-822-5400	CREVELING@NETECIN.NET
CENTURY LINK (LUMEN)	FIBER	THOMAS LONGAN		THOMAS.LONGAN@CENTURYLINK.COM
EASTERN SLOPE RURAL TELEPHONE	FIBER/PHONE	CLINT FELZIEN	719-743-2460	CLINTF@ESTRA.COM
CORE (INTERMOUNTAIN REA)	ELECTRIC	GIS DEPARTMENT		MAPS@IREA.COOP
CDOT REGION 1	ELECTRIC, FIBER, FIBER BACKBONE	JILL SCOTT	303-512-5805	JILL.SCOTT@STATE.CO.US
ZAYO BANDWITH	FIBER	ERIC BOE	303-481-6121	ERIC.BOE@ZAYO.COM

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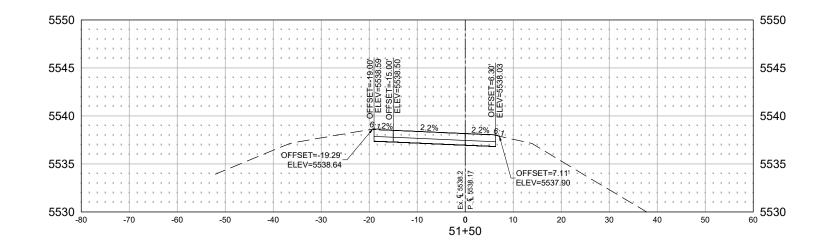
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Revised:	Designer:	A. MARQUEZ	Structure		23180R	
	Detailer:	K. KULESZA	Numbers			
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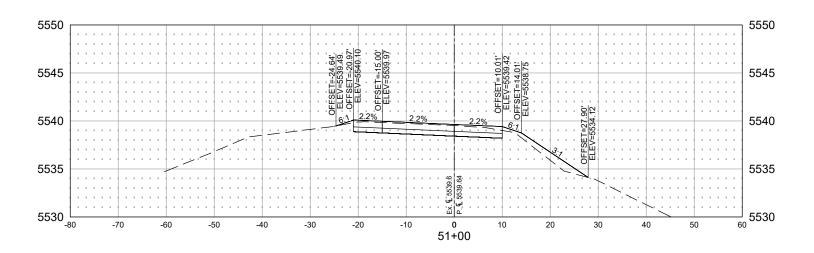
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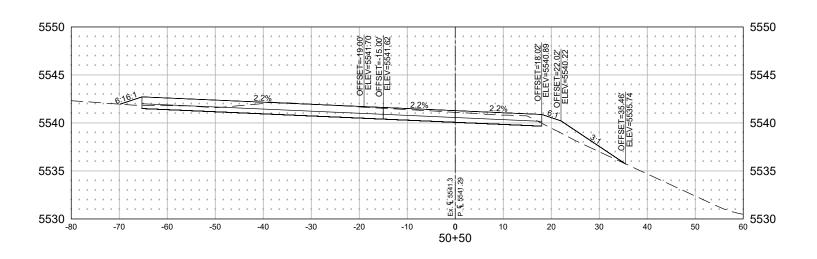
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